
NOT FOR CONSTRUCTIO

COLCORD MEADOW RESIDENTIAL SITE PLAN 12 LITTLE RIVER ROAD EXETER, NH TAX MAP 62, LOT 90

CIVIL ENGINEERS:




70 PORTSMOUTH AVE, THIRD FLOOR, SUITE 2 STRATHAM, N.H. 03885 PHONE: 603-583-4860 FAX. 603-583-4863

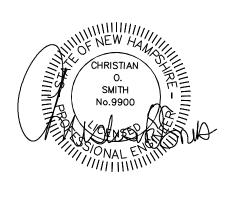

LAND SURVEYORS:



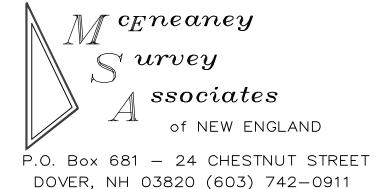

WETLAND / SOIL CONSULTANT:

GOVE ENVIRONMENTAL SERVICES INC.

8 CONTINENTAL DRIVE,

BLDG 2 UNIT H


M.
WALDEN
WALDEN

than the required minimum lot width/frontage requirements, as presented.

EXETER, NH 03833 1-603-778-0644



LOCATION MAP

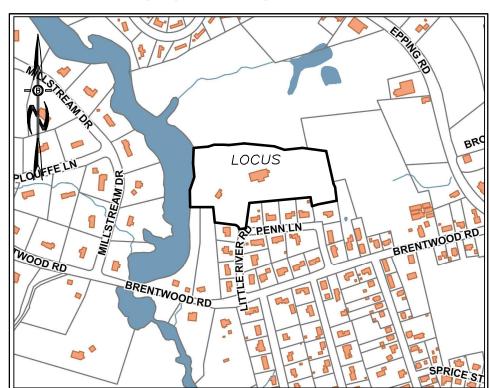

SCALE: 1"=500'

PLAN SET LEGEND

5/8" REBAR	•		
DRILL HOLE	•		
CONC. BOUND	⊡		
JTILITY POLE	Q		
DRAIN MANHOLE	(D)	OVERHEAD ELEC. LINE	
SEWER MANHOLE	S	FENCING	×
EXISTING LIGHT POLE	ф	DRAINAGE LINE	D
EXISTING CATCH BASIN		SEWER LINE	s
PROPOSED CATCH BASIN	\blacksquare	GAS LINE	————G ———
NATER GATE	₩V	WATER LINE	———W ———
WATER SHUT OFF	ngo	STONE WALL	-
HYDRANT	\$	TREE LINE	>>>>> <u>-</u>
PINES, ETC.	*	ABUT. PROPERTY LINES	
MAPLES, ETC.	6 4 5 5 5 5 5 5 5 5 5 5 5 5 5 5 5 5 5 5	EXIST. PROPERTY LINES	
EXIST. SPOT GRADE	` ጌሌፌ ና 96×69	BUILDING SETBACK LINES	
PROP. SPOT GRADE	96×69	EXIST. CONTOUR	<u> </u>
DOUBLE POST SIGN		PROP. CONTOUR	100
SINGLE POST SIGN		SOIL LINES	
	•	<u>-</u>	

INDEX

TITLE SHEET

- 1 EXISTING CONDITIONS PLAN
- 2 LOT LINE ADJUSTMENT PLAN
- 3 CONDOMINIUM SITE PLAN
- 4 YIELD PLAN
- 5 DEMOLITION/EROSION CONTROL PLAN
- 6 RESIDENTIAL SITE PLAN
- 7 PROFILE & UTILITY PLAN
- 8 CONSTRUCTION DETAILS SHEET
- 9 EROSION CONTROL DETAILS
- 10 EFFLUENT DISPOSAL DETAILS

OWNER/APPLICANT:

GRANTIE STATE CONSTRUCTION SERVICES, LLC 34 AUBURN STREET EXETER, NH

REQUIRED STATE AND FEDERAL PERMITS

NHDES SEWER EXT. #2023....

NHDES WATER EXT. #2023....

EPA CGP#.

		REVISIONS:	DATE:
	1	ISSUED 8-29-23	
	2	REVISED PER TRC REVIEW	10/10/23
PB CASE #	3	REVISED PER TRC REVIEW	11/8/23
	4		
CHAIRMAN SIGNATURE:	5		

NH-1364 PROPOSED SITE PI

СЗ

C4

C6

3166 / 290

59°07′48**°**

29°13′50°

16°08′01″

18°52′17°

20.00'

20.00'

150,00

150.00'

20.64'

10.20'

42.24'

49.41'

19.74'

10.09'

42.10'

49.18'

N24°38′19″W

N68°49'07"W

S13°47′01″W

S31°17′10″W

KNOWLEDGE AND BELIEF, SAID SURVEY MEETS OR

EXCEEDS THE MINIMUM PRECISION REQUIREMENTS

TABLE 500.1 OF THE NEW HAMPSHIRE CODE OF

ADMINISTRATIVE RULES OF THE BOARD OF

LICENSURE FOR LAND SURVEYORS."

FOR SURVEY CLASSIFICATION "U" AS SET FORTH IN

55 / 3

55 / 3-2

REFERENCE PLANS:

NO. DATE

23-2534

PROJECT NO

DESCRIPTION

REVISIONS

LLADJ

TYPE

BY CHK

FIELDBOOK & PAGES

1.) SUBDIVISION PLAN PREPARED FOR GRANITE STATE CONSTRUCTION SERVICES, LLC,

OF PROPERTY IN THE NAME OF CALVARY BAPTIST CHURCH OF EXETER, INC.,

NOTES:

1.) OWNERS OF RECORD:

GRANITE STATE CONSTRUCTION SERVICES LLC EXETER, NEW HAMPSHIRE 03833

EXETER, NEW HAMPSHIRE 03833

DENOTES TAX MAP AND PARCEL NUMBER.

THE INTENT OF THIS PLAN DEPICT THE EXISTING CONDITIONS OF THE SUBJECT PARCELS AS OF THE DATE OF THIS PLAN.

NEW AREA 218,160 S.F. (5.01 Ac.) 63,775 S.F. (1.46 Ac.)

= 15,000 S.F. / UNIT = 100 FEET = 100 FEET = 25 FEET = 15 FEET = 25 FEET = 35 FEET (3 STORIES) = 40 FEET = 50 FEET

THE EXETER ZONING BOARD OF ADJUSTMENT (CASE #21-10), AT ITS SEPTEMBER 21, 2021 MEETING, VOTED TO GRANT A VARIANCE FROM ARTICLE 4, SECTION 4.3 SCHEDULE II: DENSITY & DIMENSIONAL REGULATIONS—RESIDENTIAL TO PERMIT A PROPOSED MINOR SUBDIVISION OF THE PROPERTY LOCATED AT 12 LITTLE RIVER ROAD WITH LESS THAN THE REQUIRED MINIMUM LOT

= 75 FEET

5.) THE PARCELS ARE SUBJECT TO THE FOLLOWING EASEMENTS

A.) PARCELS ARE SUBJECT TO AN EASEMENT TO NEW ENGLAND TELEPHONE &

TELEGRAPH CO. AS DESCRIBED IN RCRD BK 992, PG 157. B.) PARCELS ARE SUBJECT TO AN EASEMENT TO ALLIED-NEW HAMPSHIRE GAS

C.) PARCEL 62/90-0 IS SUBJECT TO A USE EASEMENT TO BENEFIT MAP 62

D.) PARCELS HAVE A SHARED PRIVATE RIGHT OF WAY AS SHOWN ON

6.) A PORTION OF THE PARCEL IS LOCATED IN A FLOOD HAZARD ZONE A AS DEPICTED ON FLOOD INSURANCE RATE MAP, NO. 33015C0401E, ROCKINGHAM COUNTY, NH, (ALL JURISDICTIONS), EFFECTIVE DATE: MAY 17, 2005

THE WETLAND AREAS SHOWN HEREON WERE FIELD DELINEATED BY GOVE ENVIRONMENTAL SERVICES, INC., OF 8 CONTINENTAL DRIVE, BUILDING #2, UNIT H. EXETER, NH. in 2021, AND RE-EVALUATED AND UPDATED ON AUGÜST 1. 2023. AND PROVIDED BY BEALS ASSOCIATES, PLLC.


9.) PROPERTY LINE INFORMATION HAS BEEN OBTAINED FROM REFERENCE PLAN 2

10.) PARCELS ARE SUBJECT TO THE STATE OF NEW HAMPSHIRE SHORELINE WATER QUALITY PROTECTION ACT (SWQPA). THOSE AREAS WITHIN 250 FEET OF THE

> **EXISTING CONDITIONS PLAN** PREPARED FOR TYLER J. PETERS & OLIVIA MICHAUD

GRANITE STATE CONSTRUCTION SERVICES LLC TAX MAP 62, LOT Nos. 90-0 & 90-1 12A & 12 LITTLE RIVER ROAD TOWN of EXETER COUNTY of ROCKINGHAM

FILE: MSA\2534\D\23-2534 DATE: OCTOBER 16, 2023

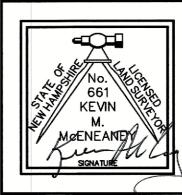


SURVEYING

f ceneaney S^{urvey} ssociatesof NEW ENGLAND


P.O. Box 681 - 24 CHESTNUT STREET DOVER, NH 03820 (603) 742-0911


PLANNING — CONSULTING

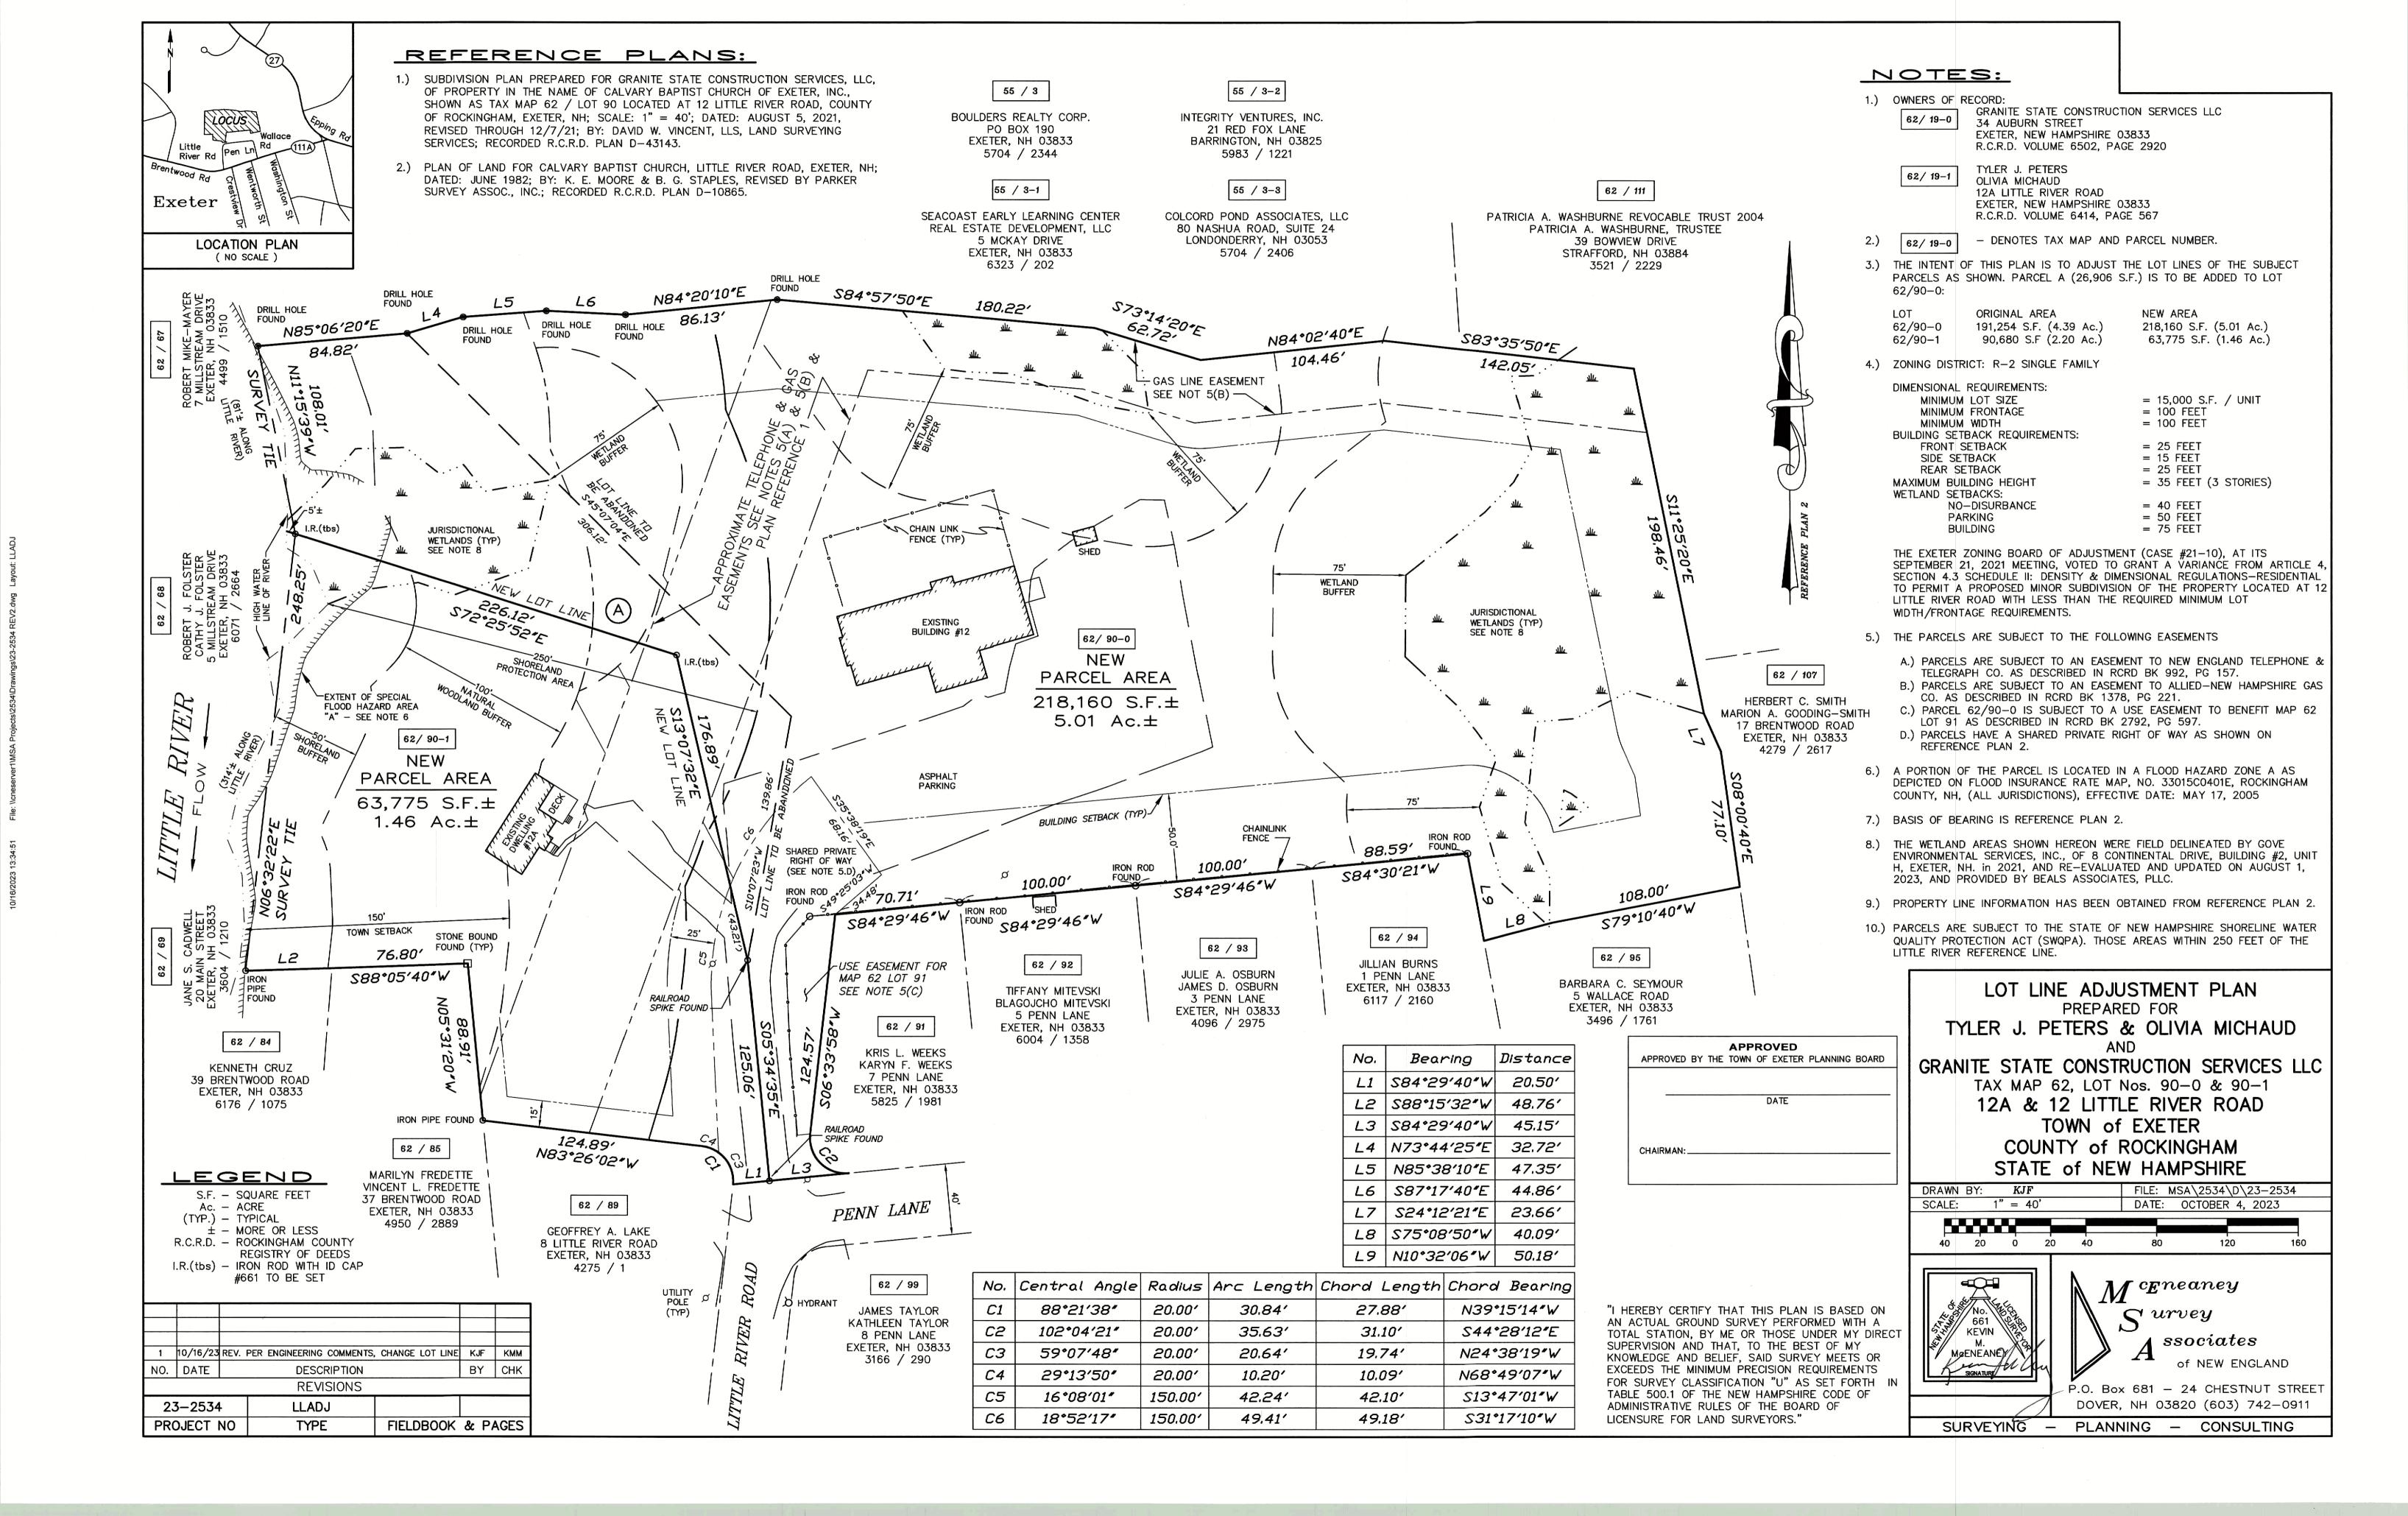



ENVIRONMENTAL SERVICES, INC., OF 8 CONTINENTAL DRIVE, BUILDING #2, UNIT


SURVEYING PLANNING - CONSULTING _

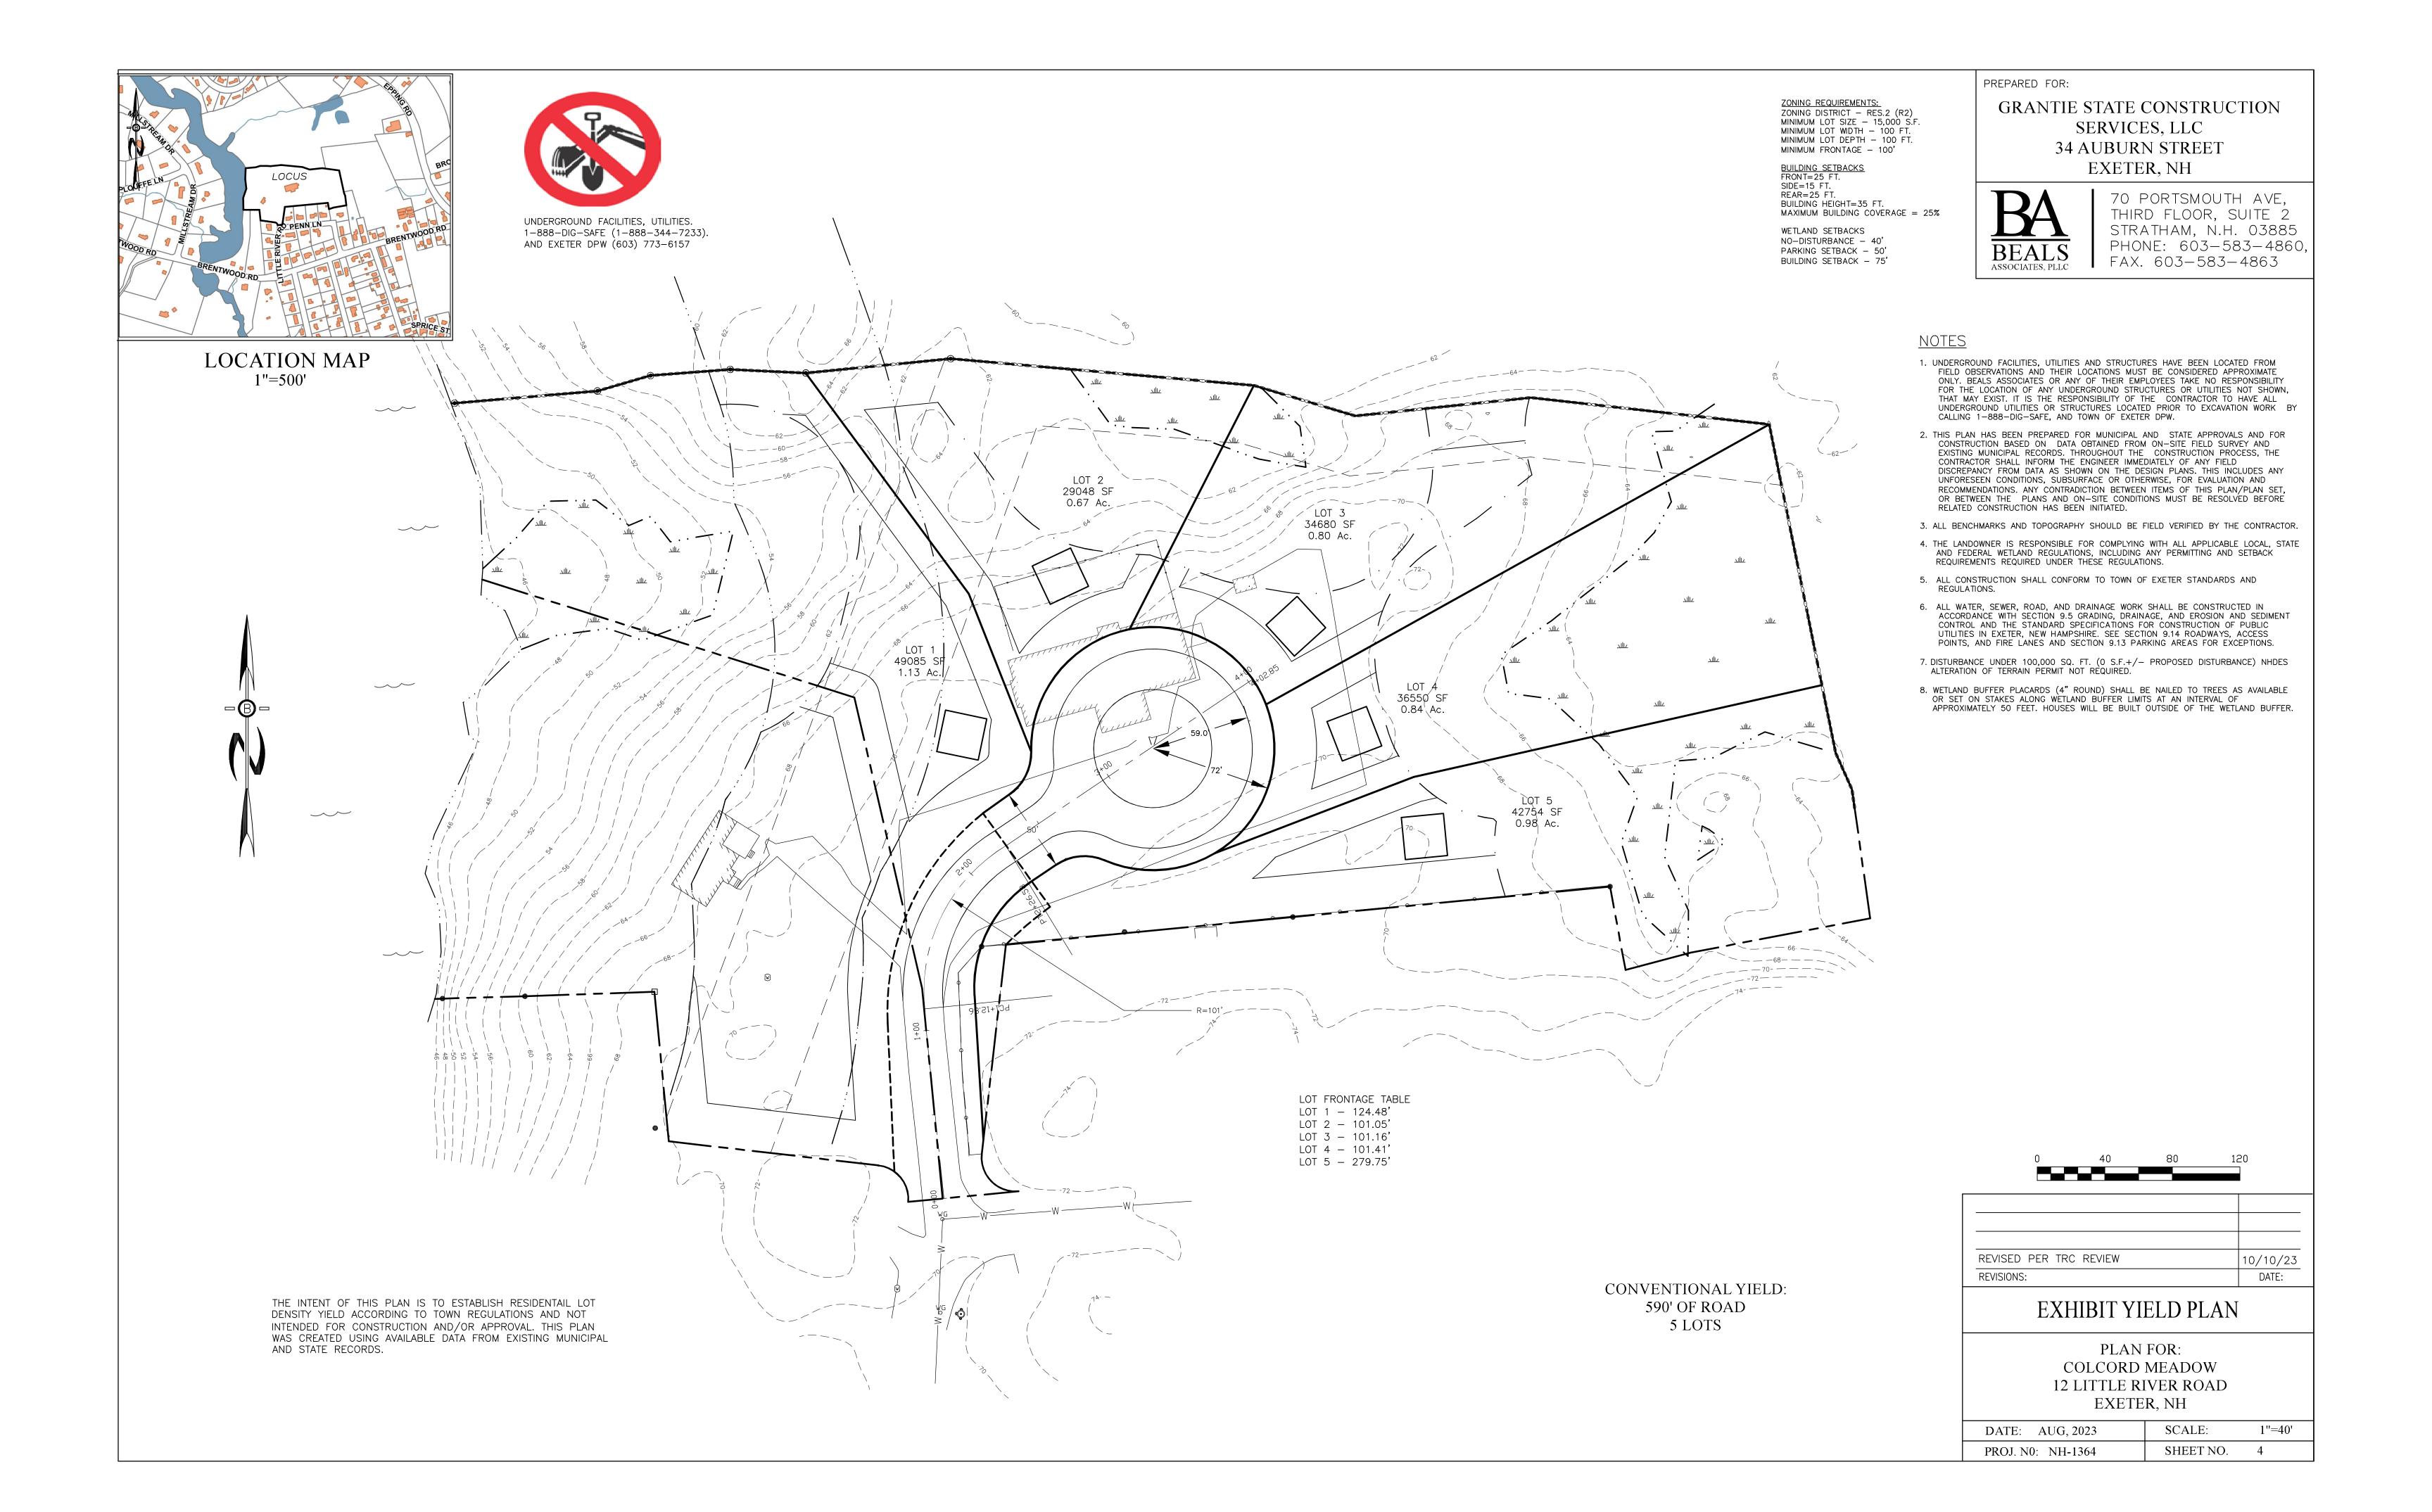

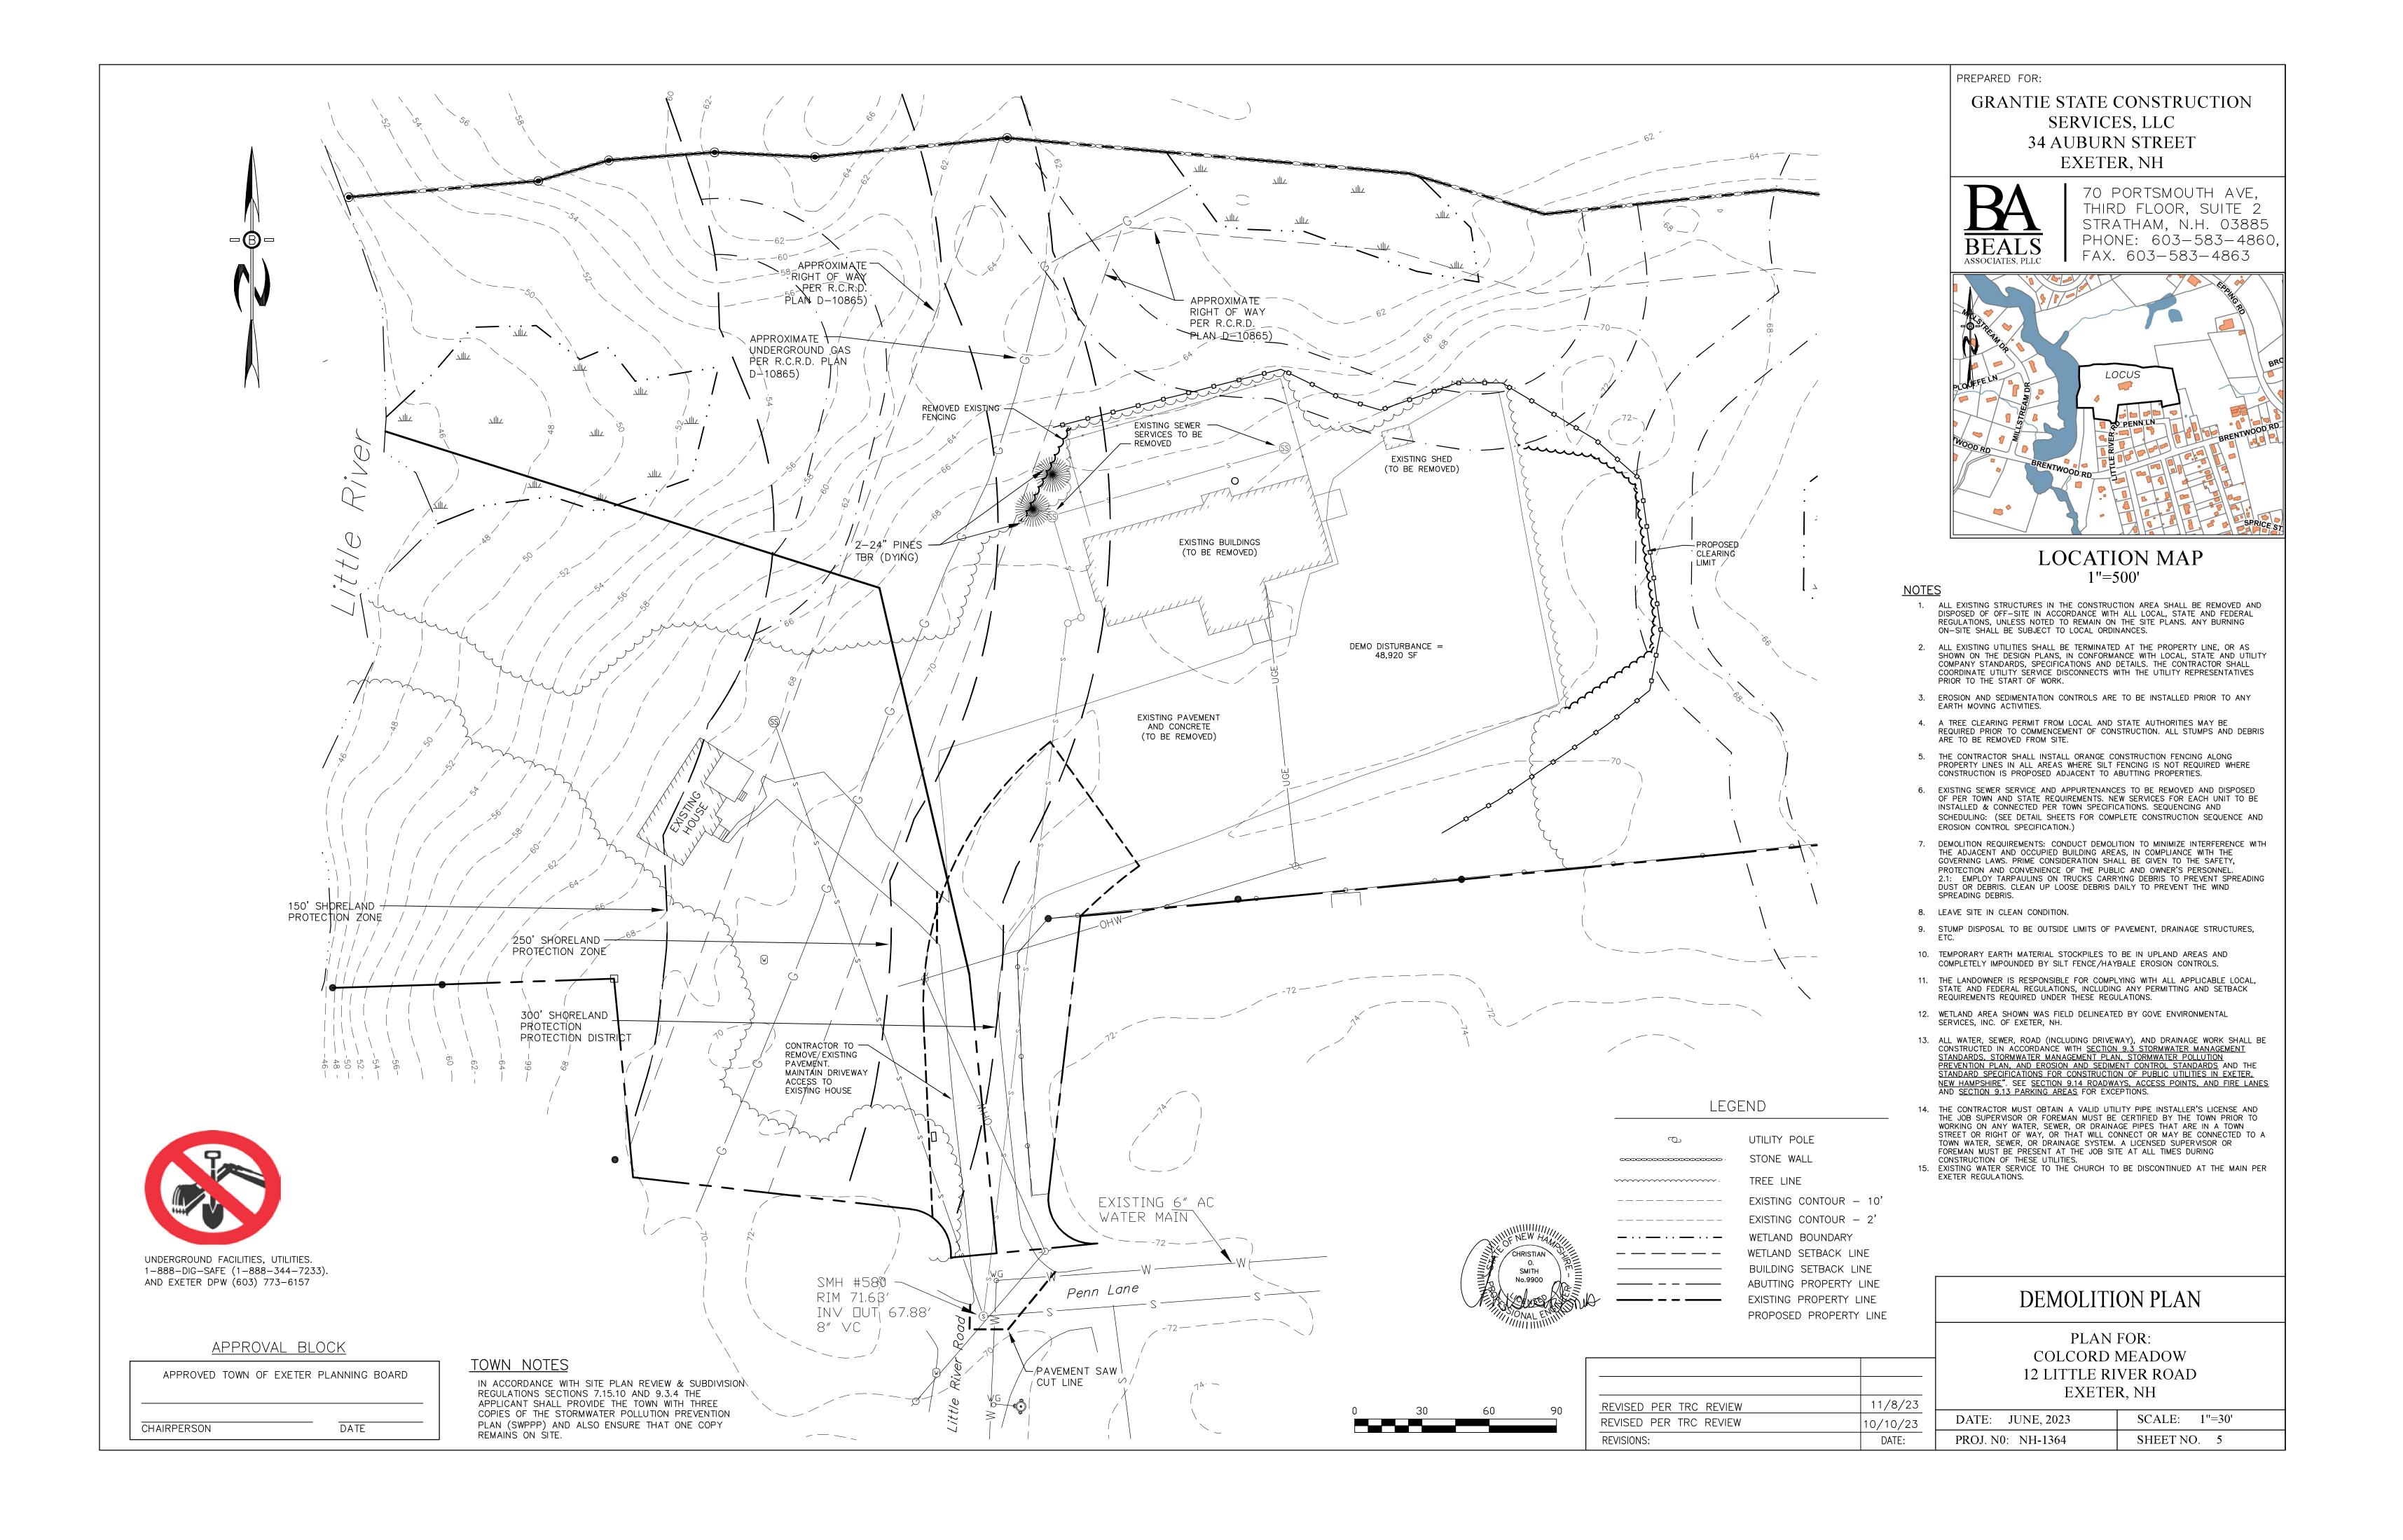

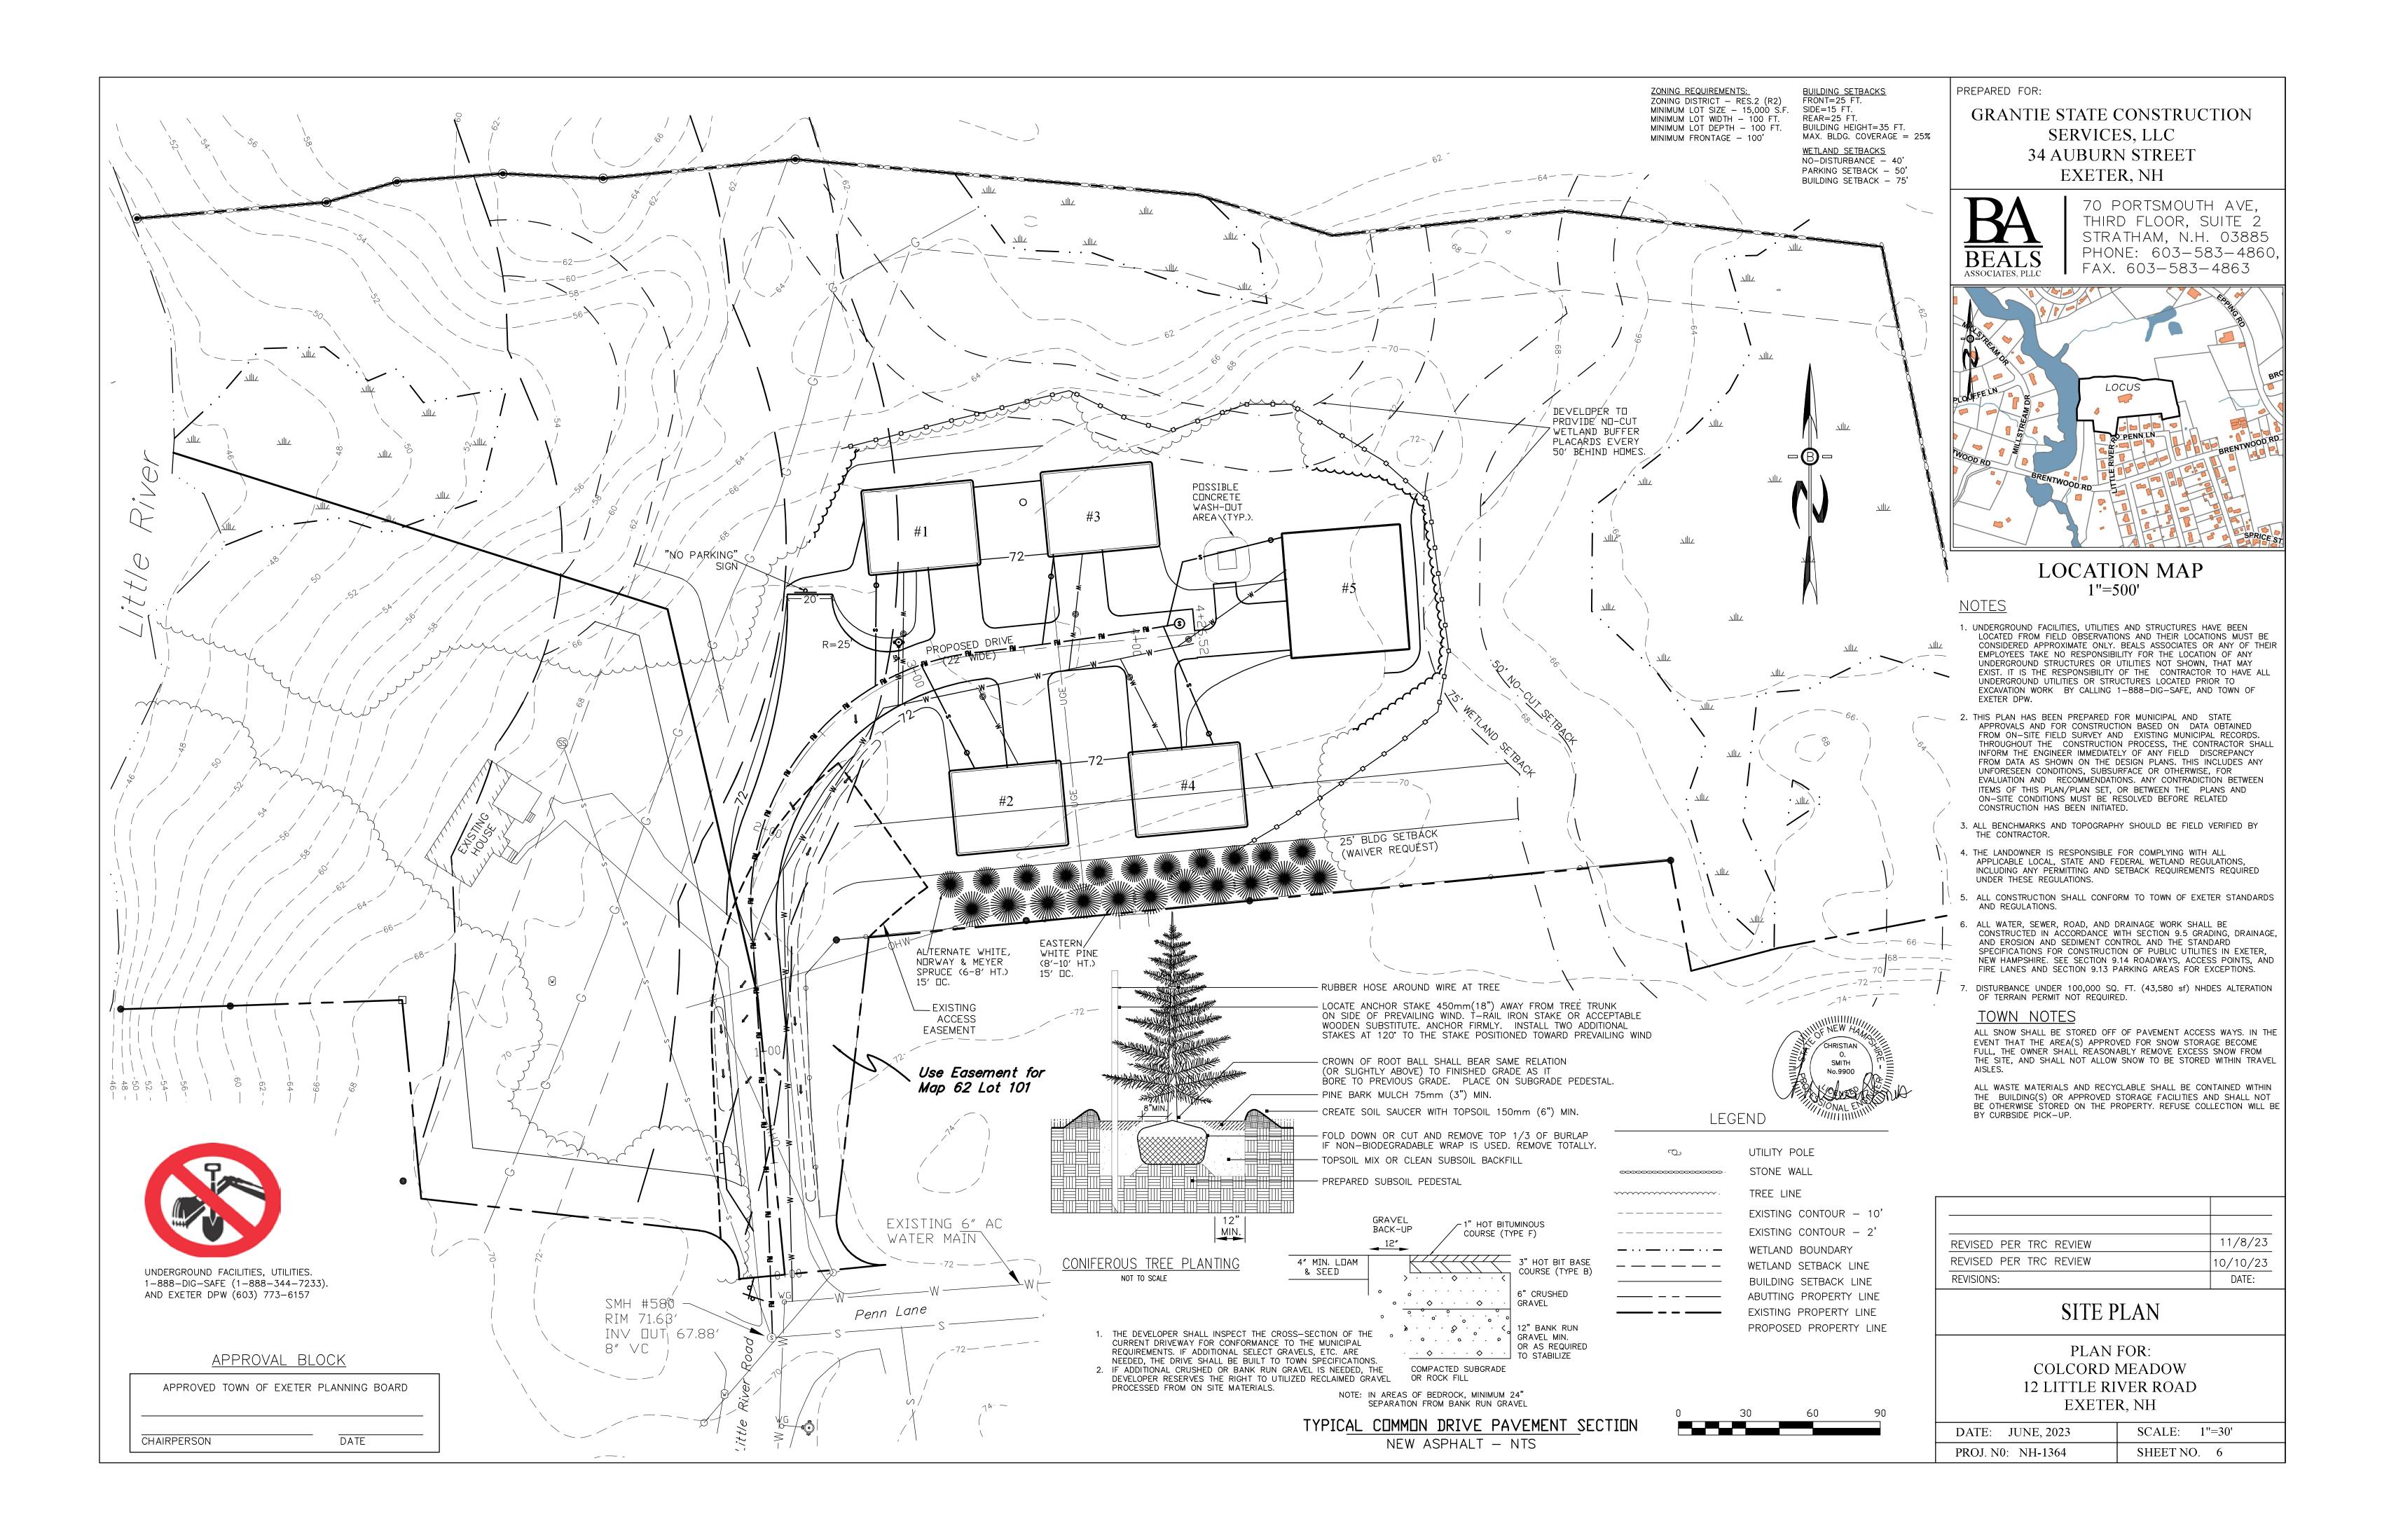

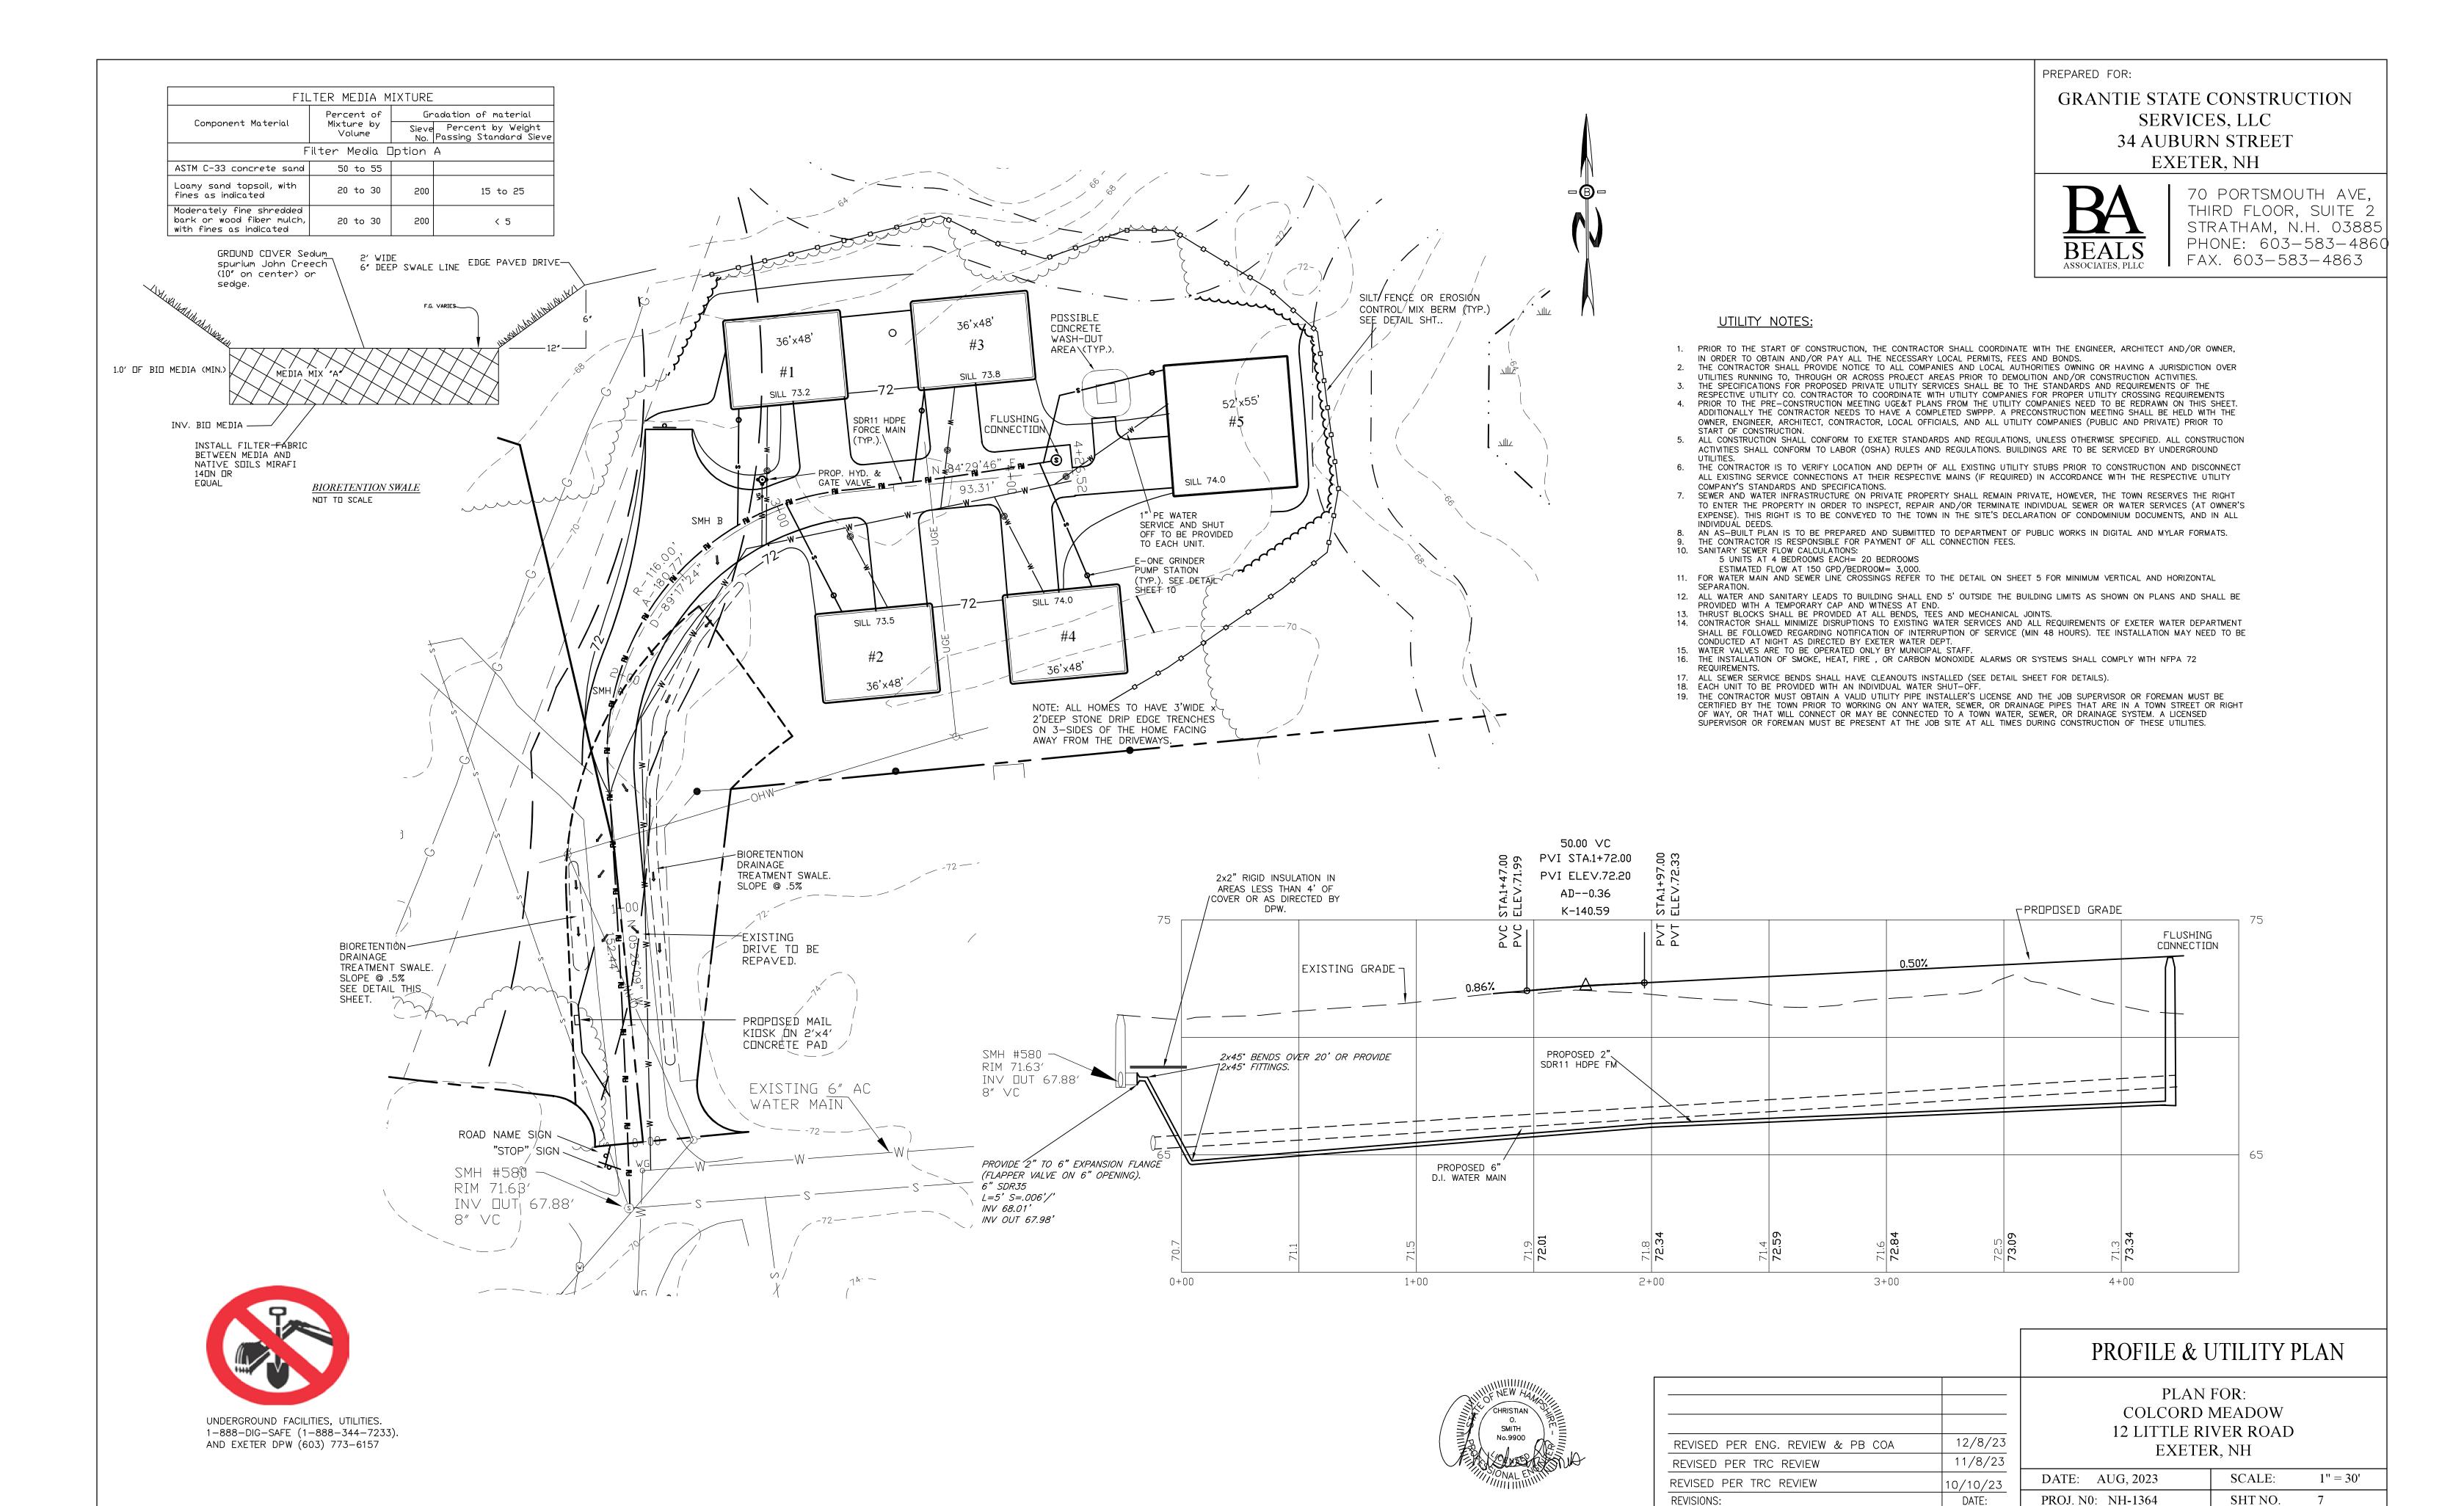


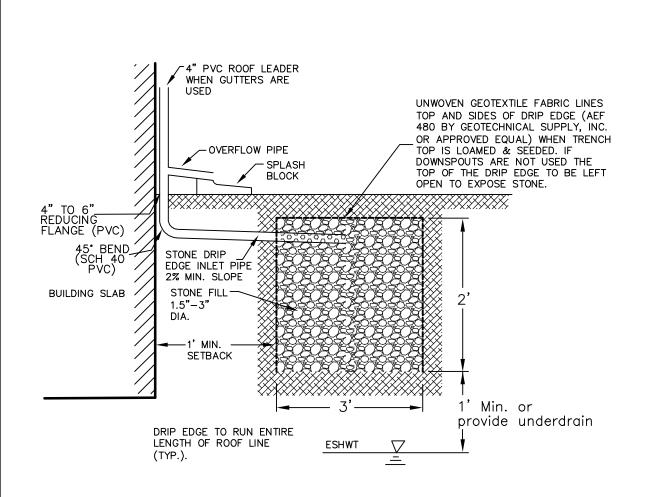


STONE DRIP EDGE SECTION

SEPARATION NOTES:


SEWERS CROSSING WATER MAINS SHALL BE LAID TO PROVIDE A MINIMUM VERTICAL DISTANCE OF 18 INCHES (460 MM) BETWEEN THE OUTSIDE OF THE WATER MAIN AND THE OUTSIDE OF THE SEWER. THIS SHALL BE THE CASE WHERE THE WATER MAIN IS EITHER ABOVE OR BELOW THE SEWER. THE CROSSING SHALL BE ARRANGED SO THAT THE SEWER JOINTS WILL BE EQUIDISTANT AND AS FAR AS POSSIBLE FROM THE WATER MAIN JOINTS. WHERE A WATER MAIN CROSSES UNDER A SEWER, ADEQUATE STRUCTURAL SUPPORT SHALL BE PROVIDED FOR THE SEWER TO MAINTAIN LINE AND

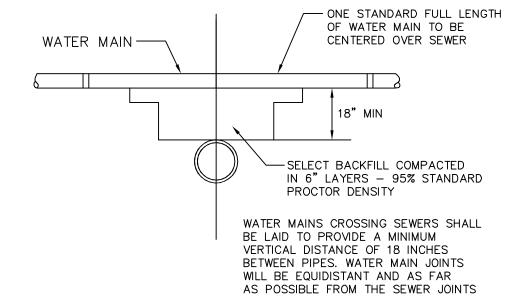

WATER/SEWER MAIN CROSSING

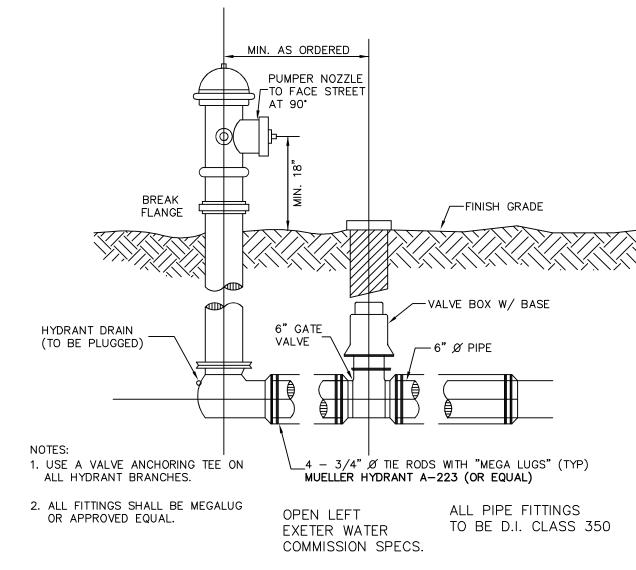

HYDRANT INSTALLATION DETAIL

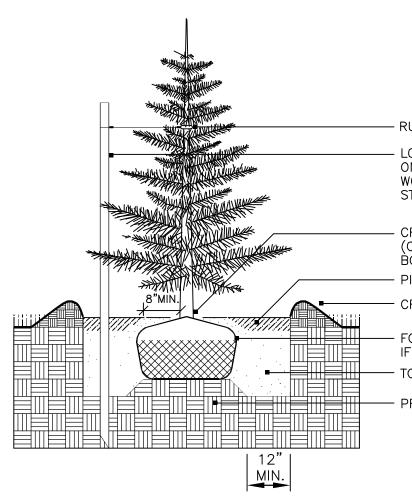


NOT TO SCALE

RUBBER HOSE AROUND WIRE AT TREE
 LOCATE ANCHOR STAKE 450mm(18") AWAY FROM TREE TRUNK
ON SIDE OF PREVAILING WIND. T-RAIL IRON STAKE OR ACCEPTABLE
WOODEN SUBSTITUTE. ANCHOR FIRMLY. INSTALL TWO ADDITIONAL
STAKES AT 120° TO THE STAKE POSITIONED TOWARD PREVAILING WIND

CROWN OF ROOT BALL SHALL BEAR SAME RELATION
 (OR SLIGHTLY ABOVE) TO FINISHED GRADE AS IT
 BORE TO PREVIOUS GRADE. PLACE ON SUBGRADE PEDESTAL.
 PINE BARK MULCH 75mm (3") MIN.
 CREATE SOIL SAUCER WITH TOPSOIL 150mm (6") MIN.

- FOLD DOWN OR CUT AND REMOVE TOP 1/3 OF BURLAP IF NON-BIODEGRADABLE WRAP IS USED. REMOVE TOTALLY.
- TOPSOIL MIX OR CLEAN SUBSOIL BACKFILL
- PREPARED SUBSOIL PEDESTAL

CONIFEROUS TREE PLANTING

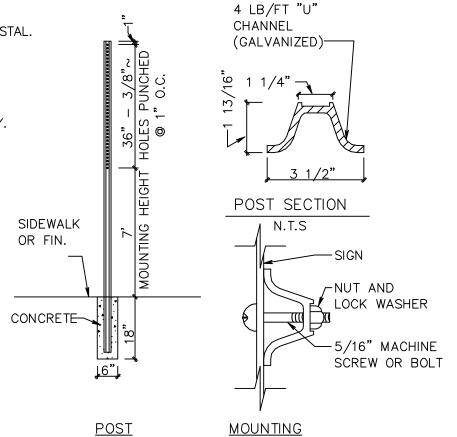

STREET SIGN DETAIL

2" PVC FORCE MAIN

CHANNEL TO BE CONSTANT

SEWER MAIN PLAN VIEW

WATER TIGHT JOINT (SEE DETAIL ON THIS SHEET)

PROPOSED 2


CONSTRUCT BRICK

INVERT ON TABLE

FORCE MAIN

3. INVERT OF 2"

2" DEPTH IN SHELF

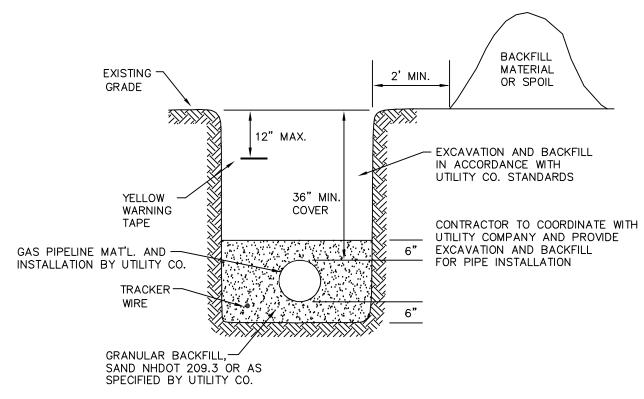

GAS TRENCH DETAIL

SECTION VIEW

EXISTING SEWER MANHOLE


EXISTING 8" SEWER

PROVIDE 45° ELBOW DIRECT FLOW


SEWER MANHOLE DETAIL


FOR CONSTRUCTION OF FORCE

MAIN INTO AN EXISTING MANHOLE

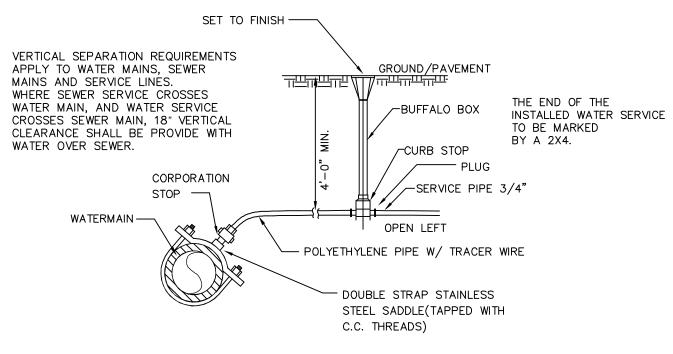

TYPICAL WATER SERVICE CONNECTION

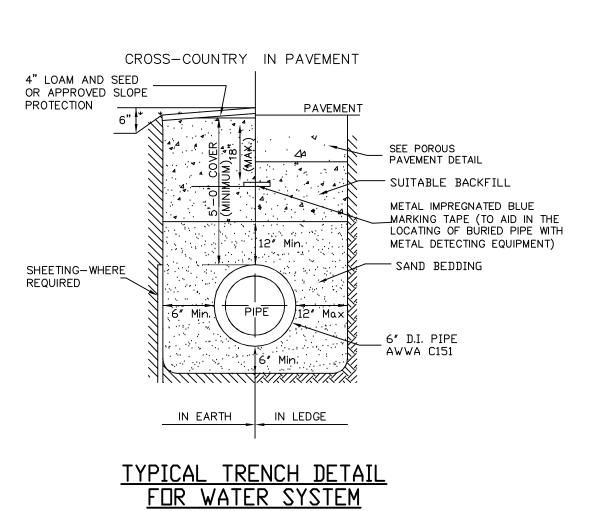

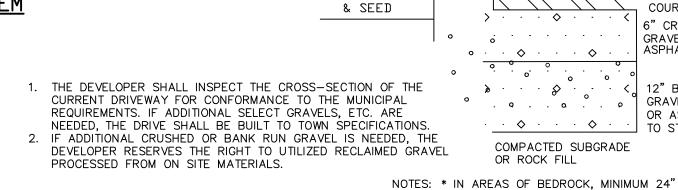

THOT BITUMINOUS
COURSE (TYPE F)

3" HOT BIT BASE
COURSE (TYPE B)
6" CRUSHED
GRAVEL OR RECLAIMED
ASPHALT

12" BANK RUN
GRAVEL MIN.
OR AS REQUIRED
TO STABILIZE

COMPACTED SUBGRADE
OR ROCK FILL

SEPARATION FROM BANK RUN GRAVEL

* PAVEMENT TRENCH PATCH SHALL MATCH
EXISTING PAVEMENT DEPTHS.


TYPICAL PAVEMENT SECTION

NEW ASPHALT

GRAVEL

4″ MIN. L□AM

BACK-UP

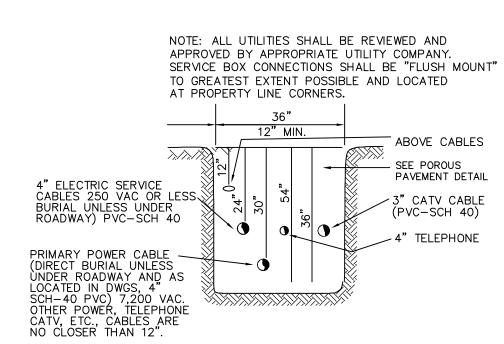


UTILITY TRENCH DETAIL


PREPARED FOR:

GRANTIE STATE CONSTRUCTION SERVICES, LLC 34 AUBURN STREET EXETER, NH



70 PORTSMOUTH AVE, THIRD FLOOR, SUITE 2 STRATHAM, N.H. 03885 PHONE: 603-583-4860 FAX. 603-583-4863

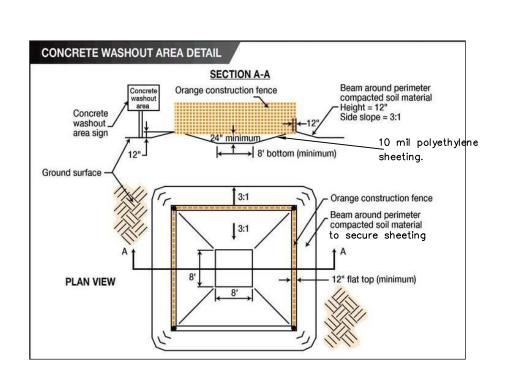

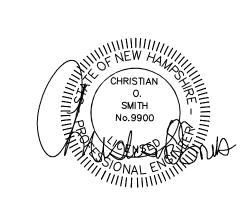

REVISED PER TRC REVIEW	10/10/23
REVISIONS:	DATE:

CONSTRUCTION DETAILS

PLAN FOR: COLCORD MEADOW 12 LITTLE RIVER ROAD EXETER, NH

	•	
DATE: AUG, 2023	SCALE:	NTS
PROJ. N0: NH-1364	SHEET NO.	8

CONSTRUCTION SEQUENCE

1. CUT AND REMOVE TREES IN CONSTRUCTION AREAS AS REQUIRED OR DIRECTED 2. CONSTRUCT AND/OR INSTALL TEMPORARY AND PERMANENT SEDIMENT EROSION AND DETENTION CONTROL FACILITIES AS REQUIRED. EROSION, SEDIMENT AND DETENTION CONTROL FACILITIES SHALL BE INSTALLED AND STABILIZED PRIOR TO ANY EARTH MOVING OPERATION AND PRIOR TO DIRECTING RUNOFF TO THEM.

3. CLEAR, CUT, GRUB AND DISPOSE OF DEBRIS IN APPROVED FACILITIES. STUMPS AND DEBRIS ARE TO BE REMOVED FROM SITE AND DISPOSED OF PER STATE AND LOCAL

4. EXCAVATE AND STOCKPILE TOPSOIL /LOAM. ALL AREAS SHALL BE STABILIZED IMMEDIATELY AFTER GRADING.

5. CONSTRUCT TEMPORARY CULVERTS AS REQUIRED OR DIRECTED

6. CONSTRUCT THE ROADWAY AND ITS ASSOCIATED DRAINAGE STRUCTURES

7. INSTALL PIPE AND CONSTRUCTION ASSOCIATED APPURTENANCES AS REQUIRED OR DIRECTED. ALL DISTURBED AREAS SHALL STABILIZED IMMEDIATELY AFTER GRADING. 8. BEGIN PERMANENT AND TEMPORARY SEEDING AND MULCHING. ALL CUT AND FILL SLOPES AND DISTURBED AREAS SHALL BE SEEDED OR MULCHED AS REQUIRED, OR DIRECTED.


9. DAILY OR AS REQUIRED, CONSTRUCT TEMPORARY BERMS, DRAINAGE CHECK DAMS, DITCHES, SEDIMENT TRAPS, ETC. TO PREVENT EROSION ON THE SITE AND PREVENT ANY SILTATION OF ABUTTING WATERS OR PROPERTY. 10. INSPECT AND MAINTAIN ALL EROSION AND SEDIMENT CONTROL MEASURES DURING

11. COMPLETE PERMANENT SEEDING AND LANDSCAPING

12. REMOVE TEMPORARY EROSION CONTROL MEASURES AFTER SEEDING AREAS HAVE ESTABLISHED THEMSELVES AND SITE IMPROVEMENTS ARE COMPLETE. SMOOTH AND RE-VEGETATE ALL DISTURBED AREAS.

13. ALL SWALES AND DRAINAGE STRUCTURES WILL BE CONSTRUCTED AND STABILIZED PRIOR TO HAVING RUNOFF DIRECTED TO THEM.

14. FINISH PAVING ALL DRIVEWAYS

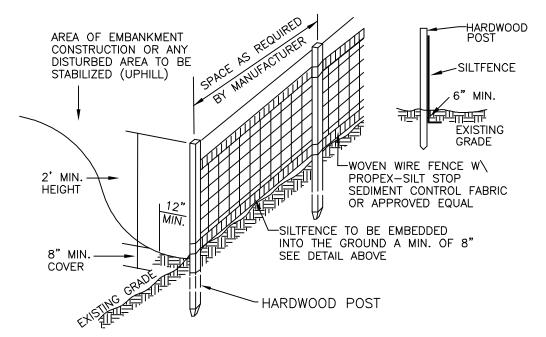

SILT FENCE CONSTRUCTION SPECIFICATIONS

1. WOVEN WIRE FENCE TO BE FASTENED SECURELY TO FENCE POSTS WITH WIRE TIES OR STAPLES AND FILTER CLOTH SHALL BE FASTENED TO WOVEN WIRE EVERY 24" AT TOP MID AND BOTTOM SECTIONS AND BE EMBEDDED INTO GROUND A MINIMUM OF 8" THE FENCE POSTS SHALL BE A MINIMUM 48" LONG, SPACED A

MAXIMUM 10' APART, AND DRIVEN A MINIMUM OF 16" INTO THE GROUND WHEN TWO SECTIONS OF FILTER CLOTH ADJOIN EACH OTHER.

3. THE ENDS OF THE FABRIC SHALL BE OVERLAPPED BY SIX INCHES, FOLDED AND STAPLED TO PREVENT SEDIMENT FROM BYPASSING MAINTENANCE SHALL BE PERFORMED AS NEEDED AND

4. REMOVED WHEN "BULGES" DEVELOP IN THE SILT FENCE AND PROPERLY DISPOSED OF PLACE THE ENDS OF THE SILT FENCE UP CONTOUR TO PROVIDE

5. FOR SEDIMENT STORAGE SILT FENCES SHALL BE REMOVED WHEN NO LONGER NEEDED AND 6. THE SEDIMENT COLLECTED SHALL BE DISPOSED AS DIRECTED BY THE ENGINEER. THE AREA DISTURBED BY THE REMOVAL SHALL BE SMOOTHED AND RE-VEGETATED

SILT FENCE MAINTENANCE

1. SILT FENCES SHALL BE INSPECTED IMMEDIATELY AFTER EACH RAINFALL AND AT LEAST DAILY DURING PROLONGED RAINFALL. ANY REPAIRS THAT ARE REQUIRED SHALL BE MADE IMMEDIATELY IF THE FABRIC ON A SILT FENCE SHOULD DECOMPOSE OR BECOME

2. INEFFECTIVE DURING THE EXPECTED LIFE OF THE FENCE, THE FABRIC SHALL BE REPLACED PROMPTLY. SEDIMENT DEPOSITS SHOULD BE INSPECTED AFTER EVERY STORM EVENT.

3. THE DEPOSITS SHOULD BE REMOVED WHEN THEY REACH APPROXIMATELY ONE HALF THE HEIGHT OF THE BARRIER. SEDIMENT DEPOSITS THAT ARE REMOVED OR LEFT IN PLACE AFTER THE

4. FABRIC HAS BEEN REMOVED SHALL BE GRADED TO CONFORM WITH THE EXISTING TOPOGRAPHY AND VEGETATED.

SEEDING SPECIFICATIONS

. GRADING AND SHAPING

A. SLOPES SHALL NOT BE STEEPER THAN 2:1;3:1 SLOPES OR FLATTER ARE PREFERRED. WHERE MOWING WILL BE DONE, 3:1 SLOPES OR FLATTER ARE RECOMMENDED.

2. SEEDBED PREPARATION A. SURFACE AND SEEPAGE WATER SHOULD BE DRAINED OR DIVERTED FROM THE SITE TO PREVENT DROWNING OR WINTER KILLING OF THE PLANTS.

B. STONES LARGER THAN 4 INCHES AND TRASH SHOULD BE REMOVED BECAUSE THEY INTERFERE WITH SEEDING AND FUTURE MAINTENANCE OF THE AREA. WHERE FEASIBLE, THE SOIL SHOULD BE TILLED TO A DEPTH OF ABOUT 4 INCHES TO PREPARE A SEEDBED AND MIX FERTILIZER AND LIME INTO THE SOIL. THE SEEDBED SHOULD BE LEFT IN REASONABLY FIRM AND SMOOTH CONDITION. THE LAST TILLAGE OPERATION SHOULD BE PERFORMED ACROSS THE SLOPE WHEREVER PRACTICAL.

4. MULCH

3. ESTABLISHING A STAND A. LIME AND FERTILIZER SHOULD BE APPLIED PRIOR TO OR AT THE TIME OF SEEDING AND INCORPORATED INTO THE SOIL KINDS AND AMOUNTS OF LIME AND FERTILIZER SHOULD BE BASED ON AN EVALUATION OF SOIL TESTS. WHEN A SOIL TEST IS NOT AVAILABLE, THE FOLLOWING MINIMUM AMOUNTS SHOULD BE APPLIED:


AGRICULTURAL LIMESTONE, 2 TONS PER ACRE OR 100 LBS PER 1,000 SQ. FT..

NITROGEN(N), 50 LBS PER ACRE OR 1. 1 LBS PER 1,000 SQ.FT.

PHOSPHATE(P205), 100 LBS PER ACRE OR 2. 2 LBS PER 1,000 SQ.FT. POTASH(K20), 100 LBS PER ACRE OR 2. 2 LBS PER 1,000 SQ.FT.


(NOTE: THIS IS THE EQUIVALENT OF 500 LBS PER ACRE OF 10-20-20 FERTILIZER OR 1,000 LBS PER ACRE OF 5-10-10.)

STABILIZED CONSTRUCTION ENTRANCE

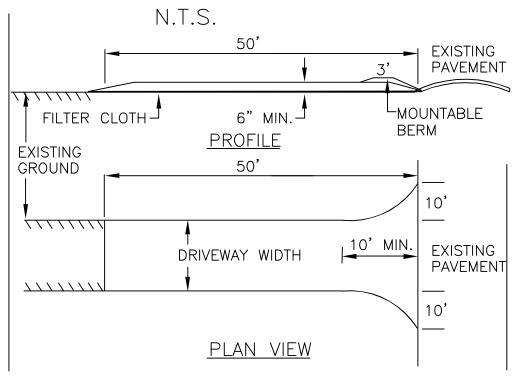

- 1. STONE FOR A STABILIZED CONSTRUCTION ENTRANCE SHALL BE 3 INCH STONE, RECLAIMED STONE, OR RECYCLED CONCRETE EQUIVALENT.
- 2. THE LENGTH OF THE STABILIZED ENTRANCE SHALL NOT BE LESS THAN 50 FEET 3. THE THICKNESS OF THE STONE FOR THE STABILIZED ENTRANCE SHALL NOT BE LESS THAN 6 INCHES. 4. THE WIDTH OF THE ENTRANCE SHALL NOT BE LESS THAN THE FULL WIDTH OF THE ENTRANCE
- WHERE INGRESS OR EGRESS OCCURS OR 10 FEET, WHICH EVER IS GREATER. 5. GEOTEXTILE FILTER CLOTH SHALL BE PLACED OVER THE ENTIRE AREA PRIOR TO PLACING THE STONE. 6. ALL SURFACE WATER THAT IS FLOWING TO OR DIVERTED TOWARD THE CONSTRUCTION ENTRANCE
- SHALL BE PIPED BENEATH THE ENTRANCE. IF PIPING IS IMPRACTICAL, A BERM WITH 5:1 SLOPES THAT CAN BE CROSSED BY VEHICLES MAY BE SUBSTITUTED FOR THE PIPE 7. THE ENTRANCE SHALL BE MAINTAINED IN A CONDITION THAT WILL PREVENT TRACKING OR FLOWING OF

SEDIMENT ONTO PUBLIC RIGHTS-OF-WAY. THIS MAY REQUIRE PERIODIC TOP DRESSING WITH ADDITIONAL STONE AS CONDITIONS DEMAND AND REPAIR AND/OR CLEAN OUT OF ANY MEASURES USED TO TRAP SEDIMENT. ALL SEDIMENT SPILLED, WASHED, OR TRACKED ONTO PUBLIC RIGHT-OF-WAY MUST BE REMOVED PROMPTLY.

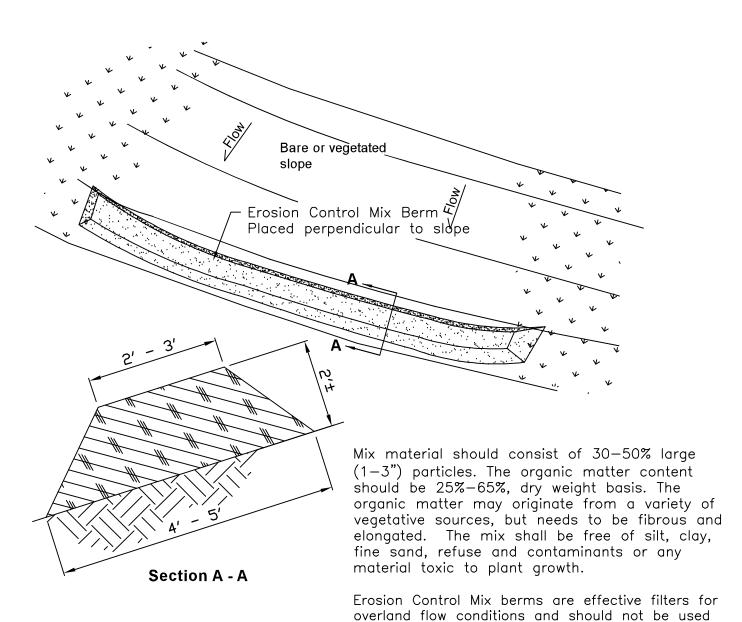

Erosion Control Mix Berm

- B. SEED SHOULD BE SPREAD UNIFORMLY BY THE METHOD MOST APPROPRIATE FOR THE SITE. METHODS INCLUDE BROADCASTING, DRILLING AND HYDROSEEDING. WHERE BROADCASTING IS USED, COVER SEED WITH .25 INCH OF SOIL OR LESS. BY CULTIPACKING OR RAKING.
- C. REFER TO TABLE(G-E1 THIS SHEET) FOR APPROPRIATE SEED MIXTURES AND TABLE(H-E1 THIS SHEET) FOR RATES OF SÈEDING. ALL LEGUMES (CROWN VETCH, BIRDS FOOT TREFOIL, AND FLAT PEA) MUST BE INOCULATED WITH THEIR SPECIFIC INOCULANT.

to filter concentrated flow such as that found in

drainage ditchs, streams, etc.

D. WHEN SEEDED AREAS ARE MULCHED, PLANTINGS MAY BE MADE FROM EARLY SPRING TO EARLY OCTOBER. WHEN SEEDED AREAS ARE NOT MULCHED, PLANTINGS SHOULD BE MADE FROM EARLY SPRING TO MAY 20 OR FROM AUGUST 10 TO SEPTEMBER 1.

- A. HAY, STRAW, OR OTHER MULCH, WHEN NEEDED, SHOULD BE APPLIED IMMEDIATELY AFTER SEEDING.
- B. MULCH WILL BE HELD IN PLACE USING APPROPRIATE TECHNIQUES FROM THE BEST MANAGEMENT PRACTICE FOR MULCHING. HAY OR STRAW MULCH SHALL BE PLACED AT A RATE OF 90 LBS PER 1000 SQ. FT.

5. MAINTENANCE TO ESTABLISH A STAND

- A. PLANTED AREA SHOULD BE PROTECTED FROM DAMAGE BY FIRE, GRAZING, TRAFFIC, AND DENSE WEED GROWTH. B. FERTILIZATION NEEDS SHOULD BE DETERMINED BY ONSITE INSPECTIONS. SUPPLEMENTAL FERTILIZER IS USUALLY THE KEY TO FULLY COMPLETE THE ESTABLISHMENT OF THE STAND BECAUSE MOST PERENNIAL STAKE 2 TO 3 YEARS TO
- BECOME ESTABLISHED. C. IN WATERWAYS, CHANNELS, OR SWALES WHERE UNIFORM FLOW CONDITIONS ARE ANTICIPATED, OCCASIONAL MOWING MAY BE NECESSARY TO CONTROL GROWTH OF WOODY VEGETATION

SEEDING RATES

2557110		
MIXTURE	POUNDS PER ACRE	POUNDS PER 1,000 Sq. Ft.
A. TALL FESCUE CREEPING RED FESCUE RED TOP TOTAL	20 20 <u>2</u> 42	0.45 0.45 <u>0.05</u> 0.95
B. TALL FESCUE CREEPING RED FESCUE CROWN VETCH OR	15 10 15	0.35 0.25 0.35
FLAT PEA TOTAL	30 40 OR 55	0.75 0.95 OR 1.35
C. TALL FESCUE CREEPING RED FESCUE BIRDS FOOT TREFOIL TOTAL	20 20 <u>8</u> 48	0.45 0.45 <u>0.20</u> 1.10
D. TALL FESCUE FLAT PEA TOTAL	20 <u>30</u> 50	0.45 <u>0.75</u> 1.20
E. CREEPING RED FESCUE 1/ KENTUCKY BLUEGRASS 1/ TOTAL	50 50 100	1.15 1.15 2.30
F. TALL FESCUE 1	150	3.60

PREPARED FOR:

GRANTIE STATE CONSTRUCTION SERVICES, LLC 34 AUBURN STREET EXETER, NH



70 PORTSMOUTH AVE. THIRD FLOOR, SUITE 2 STRATHAM, N.H. 03885 PHONE: 603-583-486 FAX. 603-583-4863

TEMPORARY EROSION CONTROL MEASURES

1. NO MORE THAN 1.58 ACRES OF LAND SHALL BE EXPOSED AT ANY ONE TIME.

2. EROSION, SEDIMENT AND DETENTION MEASURES SHALL BE INSTALLED AS SHOWN ON THE PLANS AND AT LOCATIONS AS REQUIRED OR DIRECTED BY THE ENGINEER ALL DISTURBED AREAS SHALL BE RETURNED TO ORIGINAL GRADES AND ELEVATIONS. 3. DISTURBED AREAS SHALL BE LOAMED WITH A MINIMUM OF 4" OF LOAM AND SEEDED WITH NOT LESS THAN 1.10 POUNDS OF SEED PER 1000 SQUARE FEET OF AREA. (48 POUNDS PER ACRE) SEE SEED SPECIFICATIONS THIS SHEET

- 4. SILT FENCES AND OTHER EROSION CONTROLS SHALL BE INSPECTED WEEKLY AND AFTER EVERY RAIN EVENT GREATER THAN 0.5" DURING THE LIFE OF THE PROJECT. ALL DAMAGED AREAS SHALL BE REPAIRED, SEDIMENT DEPOSITS SHALL PERIODICALLY BE REMOVED AND DISPOSED OF.
- 5. AFTER ALL DISTURBED AREAS HAVE BEEN STABILIZED, THE TEMPORARY EROSION CONTROL MEASURES ARE TO BE REMOVED AND THE AREA DISTURBED BY THE REMOVAL SMOOTHED AND RE-VEGETATED.
- 6. AREAS MUST BE SEEDED AND MULCHED WITHIN 3 DAYS OF FINAL GRADING, PERMANENTLY STABILIZED WITHIN 15 DAYS OF FINAL GRADING, OR TEMPORARILY STABILIZED WITHIN 30 DAYS OF INITIAL DISTURBANCE OF SOIL.

WINTER MAINTENANCE

1. ALL DISTURBED AREAS THAT DO NOT HAVE AT LEAST 85% VEGETATIVE COVERAGE PRIOR TO OCTOBER 15TH, SHALL BE STABILIZED BY APPLYING MULCH AT A RATE OF 3-4 TONS PER ACRE. ALL SIDE SLOPES, STEEPER THAN 4:1, THAT ARE NOT DIRECTED TO SWALES OR DETENTION BASINS, SHALL BE LINED WITH BIODEGRADABLE/PHOTODEGRADABLE "JUTE MATTING" (EXCELSIOR'S CURLEX II OR EQUAL). ALL OTHER SLOPES SHALL BE MULCHED AND TACKED AT A RATE OF 3-4 TONS PER ACRE. THE APPLICATION OF MULCH AND/OR JUTE MATTING SHALL NOT OCCUR OVER EXISTING SNOW COVER. IF THE SITE IS ACTIVE AFTER OCTOBER 15TH, ANY SNOW THAT ACCUMULATES ON DISTURBED AREAS SHALL BE REMOVED. PRIOR TO SPRING THAW ALL AREAS WILL BE STABILIZED, AS DIRECTED ABOVE.

2. ALL SWALES THAT DO NOT HAVE FULLY ESTABLISHED VEGETATION SHALL BE EITHER LINED WITH TEMPORARY JUTE MATTING OR TEMPORARY STONE CHECK DAMS (APPROPRIATELY SPACED). STONE CHECK DAMS WILL BE MAINTAINED THROUGHOUT THE WINTER MONTHS. IF THE SWALES ARE TO BE MATTED WITH PERMANENT LINERS OR RIPRAP WITH ENGINEERING FABRIC, THIS SHALL BE COMPLETED PRIOR TO WINTER SHUTDOWN OR AS SOON AS THEY ARE PROPERLY GRADED AND SHAPED.

3. PRIOR TO OCT. 15TH ALL ROADWAY AND PARKING AREAS SHALL BE BROUGHT UP TO AND THROUGH THE BANK RUN GRAVEL APPLICATION. IF THESE AREAS' ELEVATIONS ARE PROPOSED TO REMAIN BELOW THE PROPOSED SUBGRADE ELEVATION. THE SUBGRADE MATERIAL SHALL BE ROUGHLY CROWNED AND A 3" LAYER OF CRUSHED GRAVEL SHALL BE PLACED AND COMPACTED. THIS WILL ALLOW THE SUBGRADE TO SHED RUNOFF AND WILL REDUCE ROADWAY EROSION. THIS CRUSHED GRAVEL DOES NOT HAVE TO CONFORM TO NH DOT 304.3, BUT SHALL HAVE BETWEEN 15-25% PASSING THE #200 SIEVE AND THE LARGEST STONE SIZE SHALL BE 2". IF THE SITE IS ACTIVE AFTER NOVEMBER 15TH, ANY ACCUMULATED SNOW SHALL BE REMOVED FROM ALL ROADWAY AND PARKING AREAS.

4. AFTER OCTOBER 15TH, THE END OF NEW HAMPSHIRE'S AVERAGE GROWING SEASON, NO ADDITIONAL LOAM SHALL BE SPREAD ON SIDE SLOPES AND SWALES. THE STOCKPILES THAT WILL BE LEFT UNDISTURBED UNTIL SPRING SHALL BE SEEDED BY THIS DATE. AFTER OCTOBER 15TH, ANY NEW OR DISTURBED PILES SHALL BE MULCHED AT A RATE OF 3-4 TONS PER ACRE. ALL STOCKPILES THAT WILL REMAIN THROUGHOUT THE WINTER SHALL BE SURROUNDED WITH SILT FENCING.

SEEDING GUIDE MODERATELY SEEDING MIXTURE* USE DROUGHTY DRAINED DRAINED DRAINED STEEP CUTS AND POOR FILLS, BORROW AND DISPOSAL AREAS FAIR EXCELLENT EXCELLENT POOR GOOD WATERWAYS, EMERGENCY SPILLWAYS, AND OTHER CHANNELS WITH LOWING WATER. JIGHTLY USED PARKING LOTS, ODD AREAS, GOOD UNUSED LANDS, AND LOW INTENSITY USE RECREATION SITES PLAY AREAS AND FAIR FAIR EXCELLENT EXCELLENT EXCELLENT ATHLETIC FIELDS. (TOPSOIL IS ESSENTIAL FOR GOOD TURE.)

GRAVEL PIT, SEE NH-PM-24 IN APPENDIX FOR RECOMMENDATION REGARDING RECLAMATION OF SAND AND GRAVEL PITS. * REFER TO SEEDING MIXTURES AND RATES IN TABLE 7-36. ** POORLY DRAINED SOILS ARE NOT DESIRABLE FOR USE AS PLAY AREAS OR ATHLETIC FIELDS.

> NOTE: TEMPORARY SEED MIX FOR STABILIZATION OF TURF SHALL BE WINTER RYE OR DATS AT A RATE OF 2.5 LBS, PER 1000 S.F. AND SHALL BE PLACED PRIOR TO OCT. 15, IF PERMANENT SEEDING NOT YET COMPLETE.

REVISIONS:	DATE:

CHRISTIAN


SMITH


No.9900


EROSION & SEDIMENT CONTROL DETAILS

PLAN FOR: COLCORD MEADOW 12 LITTLE RIVER ROAD EXETER, NH

DATE: AUG, 2023	SCALE:	NTS'
PROJ. N0: NH-1364	SHEET NO.	9

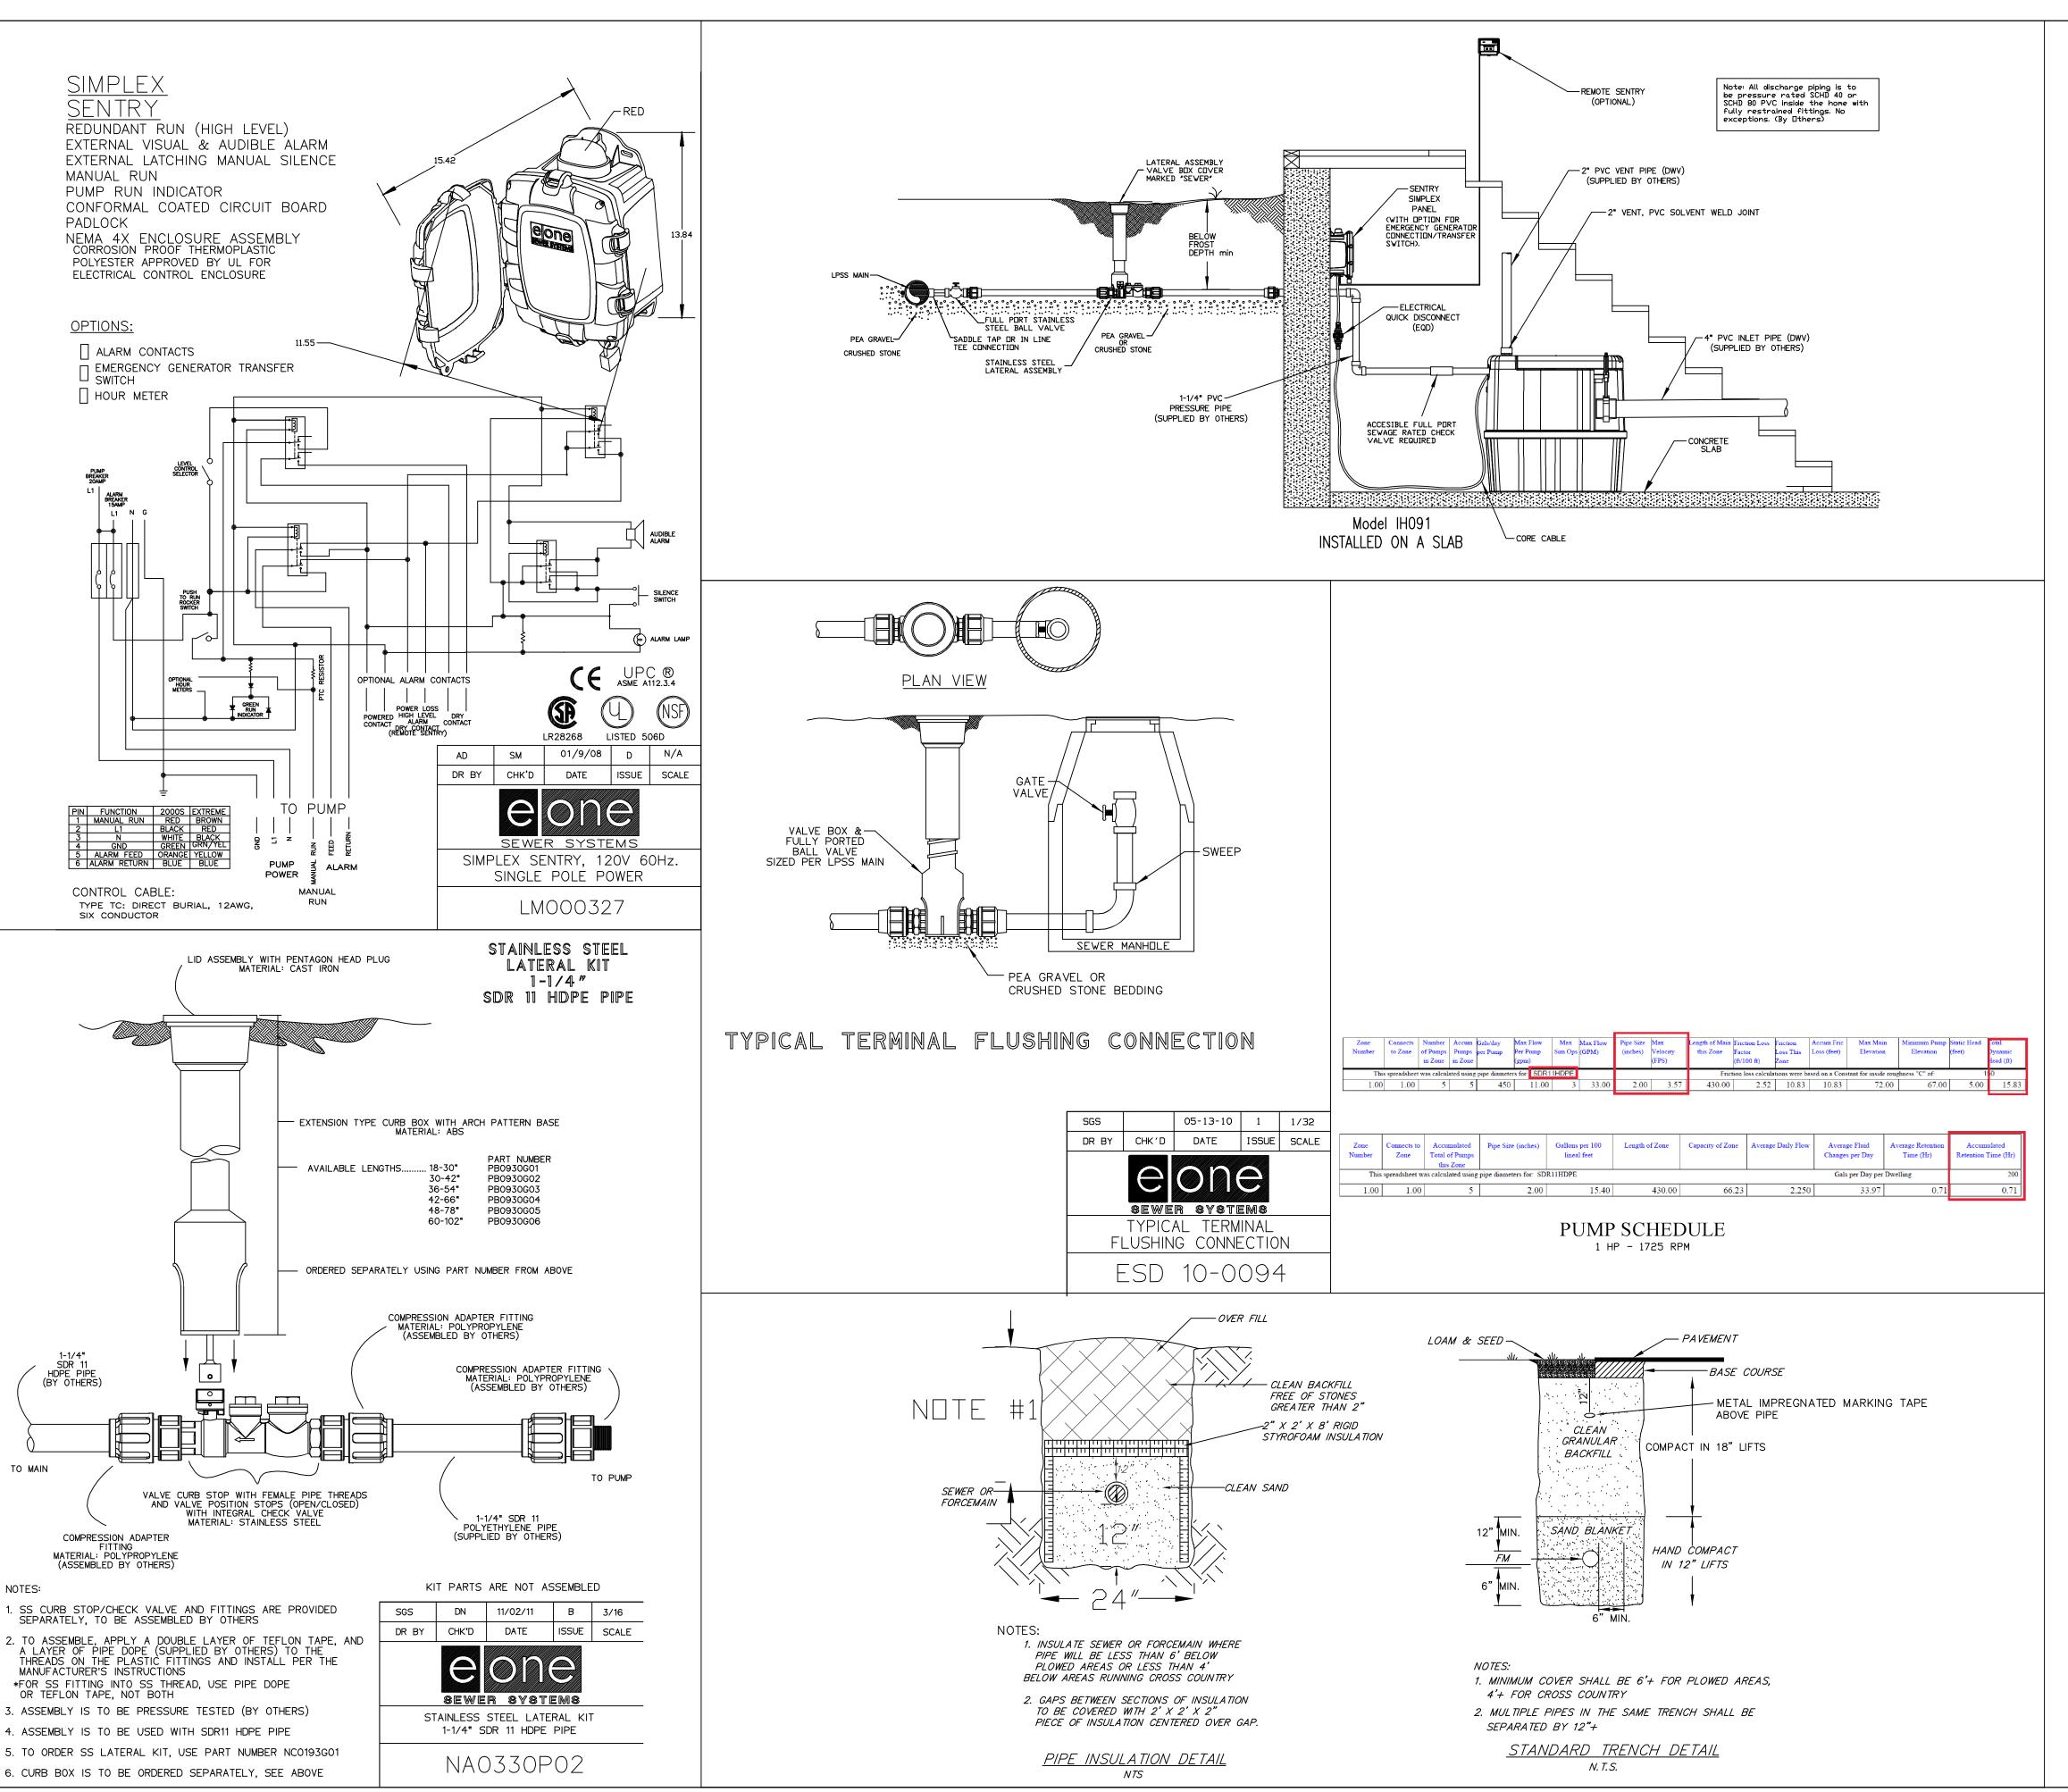

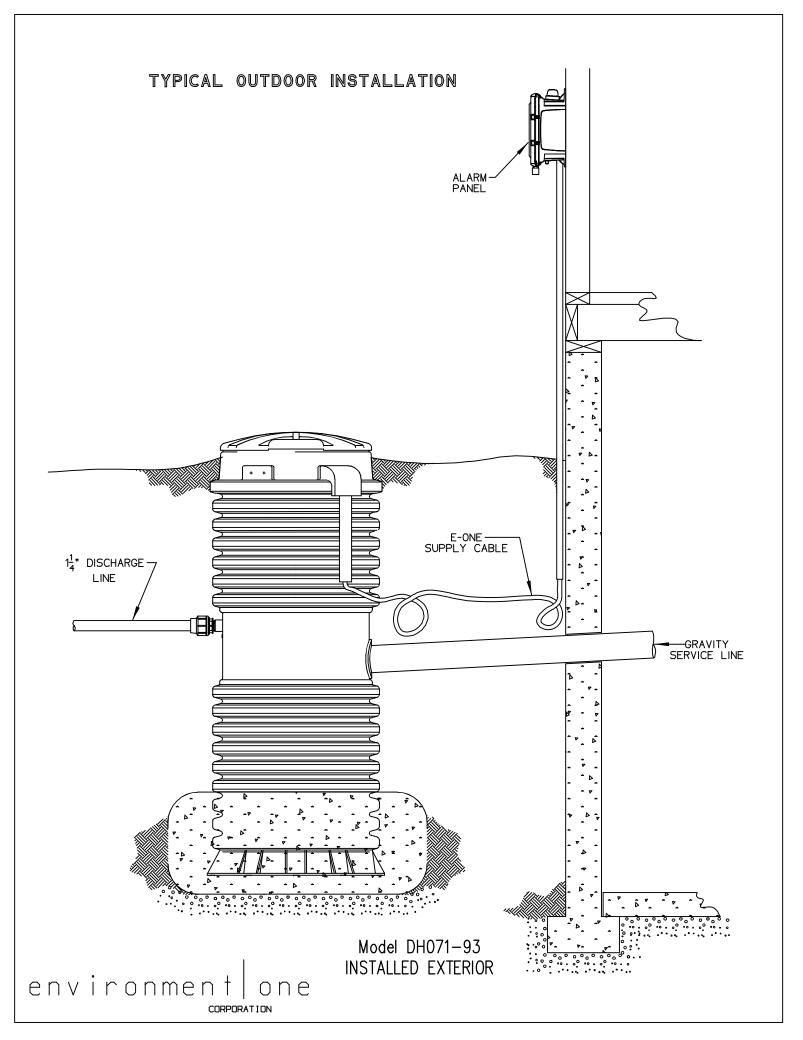

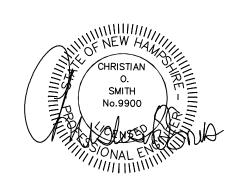

ADD TO PLAN SET	11-8-23
REVISIONS:	DATE:
	I .

EFFLUENT DISPOSAL DETAILS

PLAN FOR: COLCORD MEADOW 12 LITTLE RIVER ROAD EXETER, NH

EAETEK, NH		
DATE: AUG, 2023	SCALE:	NTSNTS
PROJ. N0: NH-1364	SHEET NO.	10